#### **STANDARDS**

- THE CITY OF RAYMORE PUBLIC IMPROVEMENT CONSTRUCTION STANDARDS
   KANSAS CITY METRO MATERIALS BOARD SPECIFICATIONS FOR CONCRETE WORK
- AMERICAN PUBLIC WORKS ASSOCIATION KANSAS CITY METROPOLITAN (APWA)

#### GENERAL NOTES

- ALL CONSTRUCTION SHALL CONFORM TO CITY OF RAYMORE, MISSOURI'S MUNICIPAL CODE AND THE GENERAL TECHNICAL SPECIFICATIONS FOR PRIVATELY FUNDED PUBLIC INFRASTRUCTURE IN EFFECT ON THE APPROVAL DATE NOTED ON THESE PLANS AND INCORPORATED HEREIN BY REFERENCE
- 2. THE CONTRACTOR SHALL PROVIDE EVIDENCE THAT THEIR INSURANCE MEETS THE REQUIREMENTS OF THE CITY OF RAYMORE, MISSOURI.
- ALL TRAFFIC CONTROL SHALL BE IN CONFORMANCE WITH THE UNIFORM TRAFFIC CONTROL DEVICES FOR THE CITY OF RAYMORE, MISSOURI TRAFFIC CONTROL HANDBOOK FOR STREET MAINTENANCE AND CONSTRUCTION OPERATIONS. COORDINATE WITH THE CITY OF RAYMORE, MO FOR ALL TRAFFIC CONTROL
- 4. THE CONTRACTOR OR THEIR CONCRETE SUPPLIER SHALL, AT THE CONTRACTOR'S EXPENSE, SUBMIT A CONCRETE MIX DESIGN FOR ANNUAL APPROVAL BY THE KANSAS CITY METRO MATERIALS BOARD (KCMMB) PRIOR TO PLACEMENT OF CONCRETE IN THE PUBLIC STREET RIGHT OF WAY, ADDITIONAL INFORMATION REGARDING KCMMB APPROVED CONCRETE MIX DESIGNS IS AVAILABLE AT WWW.KCMMB.ORG. ALL CONCRETE MIX DESIGN SHALL BE KCMMB4K.
- 5. THE CONTRACTOR IS RESPONSIBLE FOR THE PROTECTION OF ALL PROPERTY CORNERS AND SECTION CORNERS. ANY PROPERTY CORNERS AND/OR SECTION CORNERS DISTURBED OR DAMAGED BY CONSTRUCTION ACTIVITIES SHALL BE RESET BY A REGISTERED LAND SURVEYOR LICENSED IN THE STATE OF MISSOURI, AT THE CONTRACTOR'S EXPENSE.
- 6. THE CONTRACTOR SHALL BE RESPONSIBLE FOR THE RESTORATION OF THE RIGHT-OF-WAY AND FOR DAMAGED IMPROVEMENTS SUCH AS CURBS, DRIVEWAYS, SIDEWALKS, STREET LIGHT AND TRAFFIC SIGNAL JUNCTION BOXES, TRAFFIC SIGNAL LOOP LEAD INS, SIGNAL POLES, IRRIGATION SYSTEMS, ETC. DAMAGED IMPROVEMENTS SHALL BE REPAIRED IN CONFORMANCE WITH THE LATEST CITY STANDARDS AND TO THE CITY OF RAYMORE'S SATISFACTION.
- 7. LOCAL TRAFFIC WILL BE CARRIED THROUGH CONSTRUCTION.
- 8. CONTRACTOR SHALL COORDINATE ADJUSTMENTS AND RELOCATIONS WITH UTILITY COMPANIES.
- THIS DESIGN SPECIFICALLY PREPARED FOR USE AT THE LOCATION SHOWN. USE IN ANY OTHER MANNER EXCEEDS THE INTENDED PURPOSE OF THESE DRAWINGS AND ANY ACCOMPANYING SPECIFICATIONS.
- 10. THE CONTRACTOR SHALL COMPLY WITH STATE LAW REQUIRING ANY PERSON OR FIRM DOING EXCAVATION ON THE PUBLIC RIGHT-OF-WAY DO SO ONLY AFTER GIVING NOTICE TO AND OBTAINING INFORMATION FROM UTILITY COMPANIES.
- 11. EXCAVATION FOR UTILITY WORK IN THE PUBLIC STREET RIGHT-OFWAY REQUIRES A RIGHT-OF-WAY WORK PERMIT FROM THE PUBLIC WORKS DEPARTMENT, IN ADDITION TO OTHER PERMITS
- 12. THE CONTRACTOR SHALL SOD ALL DISTURBED AREAS WITHIN THE PUBLIC STREET RIGHT-OF-WAY UNLESS NOTED OTHERWISE ON THE PLANS. OR IF SPECIFIC WRITTEN APPROVAL IS PROVIDED BY THE CITY.
- 13. ROCK REMOVAL SHALL BE SUBSIDIARY.
- 14. THE CONTRACTOR SHALL COORDINATE WITH THE CITY FOR THE LOCATION OF A CONSTRUCTION ENTRANCE, STAGING AREA, AND CONCRETE WASHOUT AREAS.





# SITE PLAN REVIEW

16 JUNE 2017 **7 JULY 2017 (REVISED)** 



## RAYMORE, MISSOURI

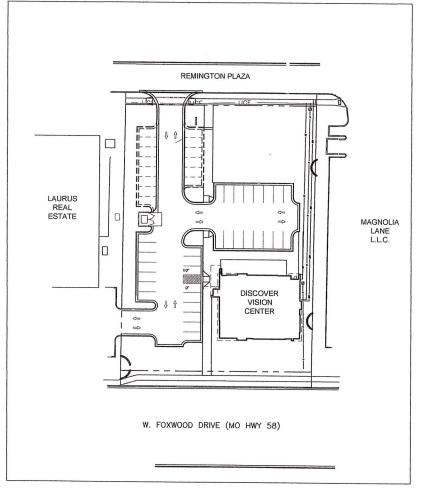

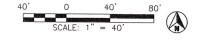


#### LEGAL / LAND DESCRIPTION:

Lot 8, REPLAT OF REMINGTON COMMERCIAL 4TH PLAT, LOTS 8 AND 9, a subdivision in Raymore, Cass County, Missouri, according to the recorded plat thereof, filed in Plat Book 18 at Page 81 and in Plat Book 22 at Page 19.

#### **BENCHMARK:**

ELEVATION = 1105.86 SET SQUARE CUT ON TOP OF CONCRETE LIGHT POLE BASE, ±100' SOUTH OF AND ±10' EAST OF THE NORTHEAST CORNER OF LOT 8.

#### VICINITY LOCATION MAP

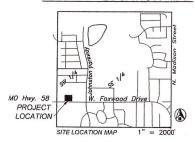

SEC. 9-46-32 RAYMORE, CASS COUNTY, MISSOUR

#### SHEET INDEX: COVER SHEET

C100

SITE PLAN

C200

GRADING, DRAINAGE & STORM SEWER PLAN

UTILITY PLAN/SANITARY SEWER PLAN C300

C400 EROSION CONTROL PLAN

LANDSCAPE

LANDSCAPE PLAN L100

BUILDING ELEVATIONS

SITE ELECTRICAL

PHOTOMETRIC PLAN

#### Civil Engineer:

#### UHL ENGINEERING, INC.



4121 W. 83rd Street, Suite 156 Shawnee Mission, Kansas (913) 385-2670 www.uhlengineering.com

#### Architect:



Guy Gronberg Architects, P.C. 113 SE 3rd St. Lee's Summit, MO 64063 (816)524-0878 www.guygronberg.com

#### MEP ENGINEER:




BC Engineers, Inc. 5720 Reeder Shawnee, KS 66203 (913)262-1772 www.bcengineer.com

#### Owner:



Discover Vision Centers 4801 Cliff Avenue - Suite 100 Independence, MO 64055 (816)350-4537 www.discovervision.com

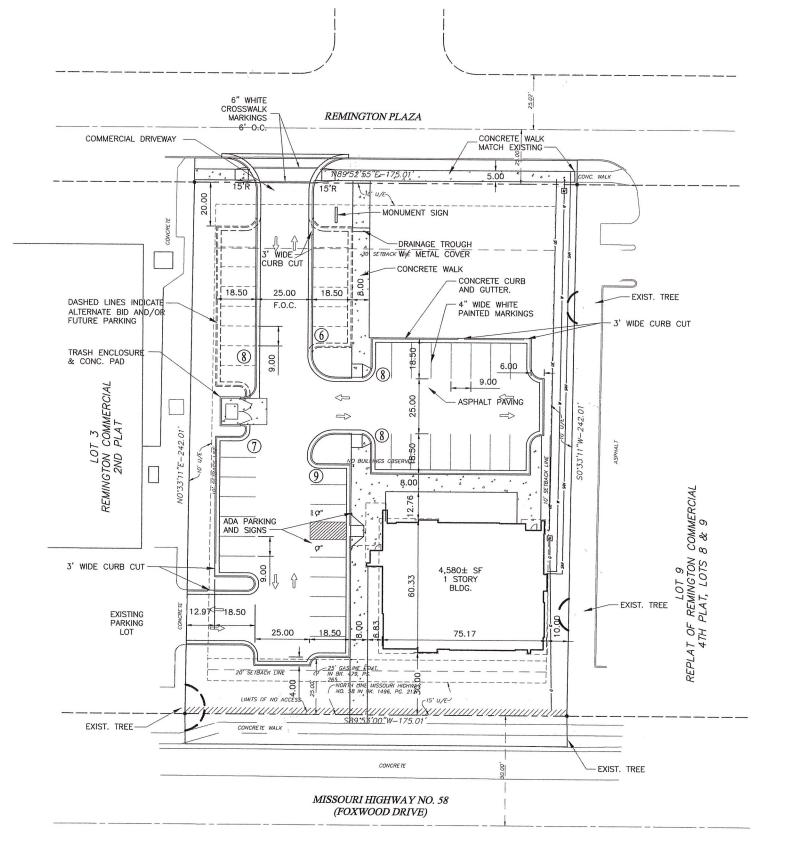

SITE PLAN:

SCALE: 1" = 20'-0"

**ZONING:** 

C-3 (INCLUDING ALL SURROUNDING AREAS)

**DEVELOPMENT DATA:** LAND AREA = 42,352 SF (0.97 ACRES)

PROPOSED BUILDING USE: MEDICAL CLINIC

BUILDING COVERAGE:

4,580 SF = 10.8% OF LOT

PARKING REQUIRED:

1 SPACE PER 600 SF

4,580/600 = 8 SPACES REQUIRED


PARKING PROVIDED:

32 SPACES

+14 ALTERNATE SPACES =46 TOTAL SPACES

(INCLUDES 2 ADA SPACES – ONE TO BE VAN ACCESSIBLE)

ALL DIMENSION ARE TO THE BACK OF CURB (B.O.C.) UNLESS NOTED OTHERWISE

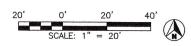



INC. UHL ENGINEERING, IR 4121 W. 83rd Street, Suite 15 Prairie Village, Kansas (913) 335-2670 www.uhlengineering.com



DISCOVER VISION CENTER 1018 W. Foxwood Drive

RAYMORE, MISSOURI

ISSUE DATE: 16 JUNE 2017
DESIGNED BY: TSU
DRAWN BY: DCC
CHECKED BY: TSU
SHEET NAME:

SITE PLAN SHEET NUMBER:

C100

RAYMORE, MISSOURI

GRADING LEGEND

GUTTER

1. CONTOUR INTERVAL IS 1 FOOT. ALL ELEVATIONS SHOWN ARE IN FEET. 2. ANY EXCESS EXCAVATION SHALL BE REMOVED FROM THE SITE AND DISPOSED

**DISTURBED AREA:** TOTAL DISTURBED AREA = 0.86 AC

SPOT ELEVATOIN

TOP OF CURB PAVEMENT

97.00

NOTES:

OF PROPERLY.

TC


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ISSUE DATE: 16 JUNE 2017
DESIGNED BY: TSU
DRAWN BY: DCC
CHECKED BY: TSU
SHEET NAME:
GRADING, DRAINAGE &

STORM SEWER PLAN

SHEET NUMBER: C200

REMINGTON PLAZA

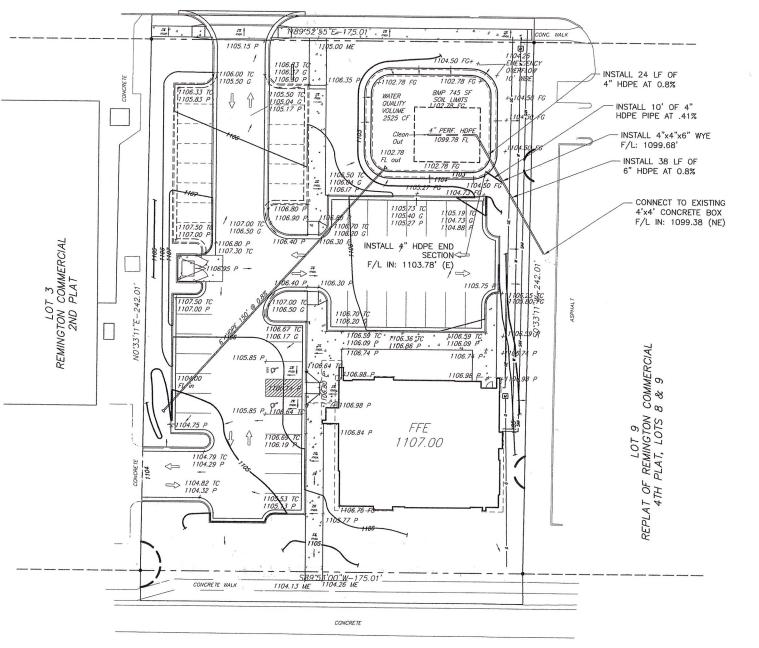

MISSOURI HIGHWAY NO. 58 (FOXWOOD DRIVE)

#### UTILITY INFORMATION

NOTE: 48 HOURS PRIOR TO COMMENCEMENT OF CONSTRUCTION, THE CONTRACTOR SHALL NOTIFY THE FOLLOWING COMPANIES FOR FIELD VERIFICATION OF THE UNDERGROUND UTILITIES.

CITY OF RAYMORE (STREET LIGHTS, ETC.) CITY OF RAYMORE WATER/SEWER U.S. TELECOM (FIBER OPTICS)	816-331-5182 816-331-5182 1-800-521-0579
AT&T CABLE HAZARD CENTER	1-800-252-1133
VONAGE	1-888-218-9015
COMCAST	816-795-1100
KANSAS CITY POWER & LIGHT CO-ELECT.	816-471-5275
GOOGLE FIBER	866-777-7550
MISSOURI GAS ENERGY / LACLEED	800-582-1234
SOUTHWESTERN BELL TELEPHONE	
CASS COUNTY WASTEWATER	816-380-8134


#### **UTILITY NOTES:**

VISUAL INDICATIONS OF UTILITIES ARE AS SHOWN. UNDERGROUND LOCATIONS SHOWN, AS FURNISHED BY THEIR LESSORS, ARE APPROXIMATE AND SHOULD BE VERIFIED IN THE FIELD AT TIME OF CONSTRUCTION. FOR ACTUAL FIELD LOCATIONS OF UNDERGROUND UTILITIES, CALL 811 OR 1-800-344-7483 (DIG RITE)

THE CONTRACTOR SHALL ADHERE TO THE PROVISIONS OF THE SENATE BILL NUMBER 583, 78TH GENERAL ASSEMBLY OF THE STATE OF MISSOURI. THE BILL REQUIRES THAT ANY PERSON OR FIRM DOING EXCAVATION ON PUBLIC RIGHT— OF-WAY DO SO ONLY AFTER GIVING NOTICE TO, & OBTAINING INFORMATION FROM, UTILITY COMPANIES. STATE LAW REQUIRES 48 HOURS ADVANCE NOTICE. CALL 1-800-DIG-RITE OR 811.





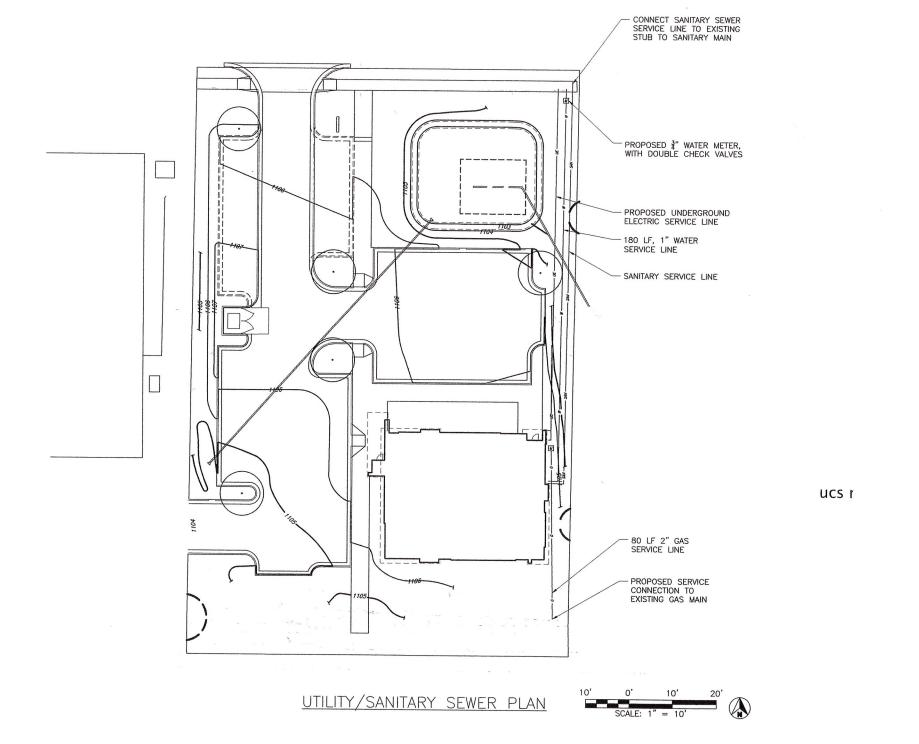



INC. UHL ENGINEERING, II
4121 W. 83rd Street, Suite 15
Prairie VIllage, Kansas
(913) 385-2670
www.uhlengineering.com



DISCOVER VISION CENTER 1018 W. Foxwood Drive

RAYMORE, MISSOURI

ISSUE DATE: 16 JUNE 2017
DESIGNED BY: TSU
DRAWN BY: DCC
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SHEET NAME:
UTILITY/SANITARY
SEM/ER DI AN

SEWER PLAN
SHEET NUMBER:

C300

#### SEQUENCE OF EXCAVATION/WORK ACTIVITIES

THE FOLLOWING LIST GENERALLY DESCRIBES THE INTENDED SEQUENCE OF MAJOR ACTIVITIES WHICH DISTURB THE SOILS.


THE ESTIMATED DURATION OF LAND DISTURBANCE IS 120 DAYS.

- MARK CONSTRUCTION LIMITS. CLEAR AND GRUB AREAS REQUIRED FOR PERIMETER EROSION CONTROL AND DEVICES.
- INSTALL PERIMETER EROSION AND SEDIMENT CONTROL ITEMS. EROSION CONTROL SHALL BE INSTALLED PRIOR TO THE BEGRIMING OF SITE WORK.
- INSPECT CONTROL MEASURES PRIOR TO CONSTRUCTION COMMENCEMENT.
- INSTALL STABILIZED CONSTRUCTION ENTRANCE.
- STRIP TOPSOIL AND STOCKPILE. ADD ANY ADDITIONAL RUNOFF PROTECTION.
- PERFORM MASS GRADING.
- INSTALL STABILIZED CONSTRUCTION STAGING AND PARKING, AS REQUIRED.
- INSTALL CONCRETE WASHOUT BASIN.
- STABILIZE AREAS WITH VEGETATION, OR OTHER APPROPRIATE MEANS, THAT WILL BE EXPOSED FOR A PERIOD OF TIME. STABILIZE STEEP SLOPES.
- NSTALL ANY ADDITIONAL CONSTRUCTION EROSION CONTROL ITEMS.
- INSTALL INFRASTRUCTURE IMPROVEMENTS (I.E. UTILITIES, STORM SEWERS, PARKING SURFACE).
- INSPECT PRIOR TO COMMENCEMENT OF BMP CONSTRUCTION.
- 13. PERFORM FINAL GRADING.
- CONSTRUCTION OF STORMWATER BMP'S.
- REMOVE SILT, AS NECESSARY.
- STABILIZE THE REMAINDER OF THE SITE.
- REMOVE EROSION CONTROL DEVICES ONCE GROUND COVER IS ESTABLISHED.

#### **EROSION CONTROL NOTES:**

- 1. ALL WORK IN PUBLIC EASEMENTS AND RIGHT-OF-WAY AND ALL EROSION CONTROL WORK MUST COMPLY WITH THE LATEST EDITION OF THE TECHNICAL PROVISIONS AND STANDARD DRAWINGS FOR ROAD AND SEWERS, OF THE CITY OF RAYMORE, MISSOURI IF ANY OF THE GENERAL NOTES CONFLICT WITH THE RAYMORE'S STANDARDS. THE RAYMORE'S STANDARDS SHALL OVERRIDE.
- 2. ALL REQUIREMENTS OF KC APWA SECTION 2150 SHALL BE SATISFIED BOTH DURING CONSTRUCTION AND
- 3. THE PROPOSED CONSTRUCTION ENTRY, STOCKPILE AREA AND CONCRETE WASH-OUT PIT SHALL BE IDENTIFIED PRIOR TO BEGINNING WORK.
- THE CONTRACTOR SHALL MAINTAIN EROSION CONTROL DEVISES AND SEDIMENT REMOVAL UNTIL 70% OF PERMANENT VEGETATION HAS BEN ESTABLISHED AND ESTABLISHED. EROSION CONTROL DEVICES SHALL REMAIN IN PLACE UNTIL THE 70% ESTABLISHED VEGETATION IS MET, OR THE DURATION OF THE PROJECT, WHICHEVER IS THE LATER DATE.
- 5. CONTRACTOR SHALL INSPECT EROSION CONTROL DEVICES EVERY 7 DAYS AND WITHIN 24 HOURS OF A STORM EVENT OF 0.5 INCHES OR MORE. THE CONTRACTOR SHALL REPAIR DAMAGE, CLEAN OUT SEDIMENT, AND ADD ADDITIONAL EROSION CONTROL AS NEEDED, AS SOON AS PRACTICABLE, AFTER INSPECTION.
- PRIOR TO INITIAL SOIL DISTURBANCE OR RE-DISTURBANCE, PERMANENT OR TEMPORARY EROSION CONTROL SHALL BE COMPLETED ON ALL PERIMETER DIKES, SWALES, DITCHES, PERIMETER SLOPES, AND ALL SLOPES GREATER THAN 3 HORIZONTAL TO 1 VERTICAL (3:1); EMBANKMENTS OF PONDS, BASINS, AND TRAPS. SEDIMENT CONTROL SHALL BE COMPLETED WITHIN FOURTEEN (14) CALENDAR DAYS ON ALL DISTURBED OR GRADED AREAS. THE REQUIREMENTS OF THIS SECTION DO NOT APPLY TO THOSE AREAS THAT ARE SHOWN ON THE PLAN AND ARE CURRENTLY BEING USED FOR MATERIAL STORAGE OR FOR THOSE AREAS WHICH ACTUAL CONSTRUCTION ACTIVITIES ARE CURRENTLY BEING PERFORMED.
- 7. THE CONTRACTOR SHALL TEMPORARY SEED, MULCH OR OTHERWISE STABILIZE ANY DISTURBED AREA WHERE LAND DISTURBANCE ACTIVITY HAS CEASED FOR A PERIOD OF FOURTEEN (14) CALENDAR DAYS.
- 8. THE CONTRACTOR SHALL BE RESPONSIBLE FOR PROVIDING ADDITIONAL EROSION CONTROL MEASURES OF MODIFICATIONS IF THE PLAN FAILS TO SUBSTANTIALLY CONTROL EROSION OF OFFSITE SEDIMENTATION.
- GOOD HOUSEKEEPING PRACTICES SHALL BE PERFORMED, INCLUDING SPILL RESPONSE SHALL BE PERFORMED IN ACCORDANCE WITH THE KC APWA STANDARD SPECIFICATIONS, SECTION 2150.
- 10. THE CONTRACTOR SHALL PROVIDE ALL MATERIALS, TOOLS, EQUIPMENT AND LABOR AS NECESSARY TO INSTALL AND MAINTAIN ADEQUATE EROSION CONTROL, KEEP THE STREETS CLEAN OF MUD AND DEBRIS, AND PREVENT SOIL FROM LEAVING THE PROJECT SITE. THE CONTRACTOR'S EROSION CONTROL MEASURES SHALL CONFORM TO THE CITY OF RAYMORE, MISSOURI'S TECHNICAL PROVISIONS SPECIFICATIONS, AND THE PROJECT'S STORMWATER POLLUTION PREVENTION PLAN, A COPY OF WHICH SHALL BE MAINTAINED AND UPDATE ON SITE AT ALL TIMES.

EROSION AN	D SEDIMENT CONTROL :	STAGING CHART	
PROJECT STAGE	BMP PLAN BMP DESCRIPTION REF. NO.	MAYBE REMOVED NOTES: AFTER STAGE:	
A - PRIOR TO LAND DISTURBANCE	1 CONSTRUCTION ENTRANCE 2 PARKING & STAGING AREA 3 SILT FENCE & TREE PRESE 4 STOCKPILE 5 SILT FENCE 6 AREA INLET PROTECTION	RVATION D IF NEED	KPILE IS NEEDED
B — AFTER GRADING	7 CONCERT WASH OUT	D	
C - PRIOR TO PAVING			
D – AFTER CONSTRUCTION COMPLETED AND VEGETATION IS ESTABLISHED	8 SEEDING & MULCHING	D SEED O	R SOD ALL DISTURBED AREA

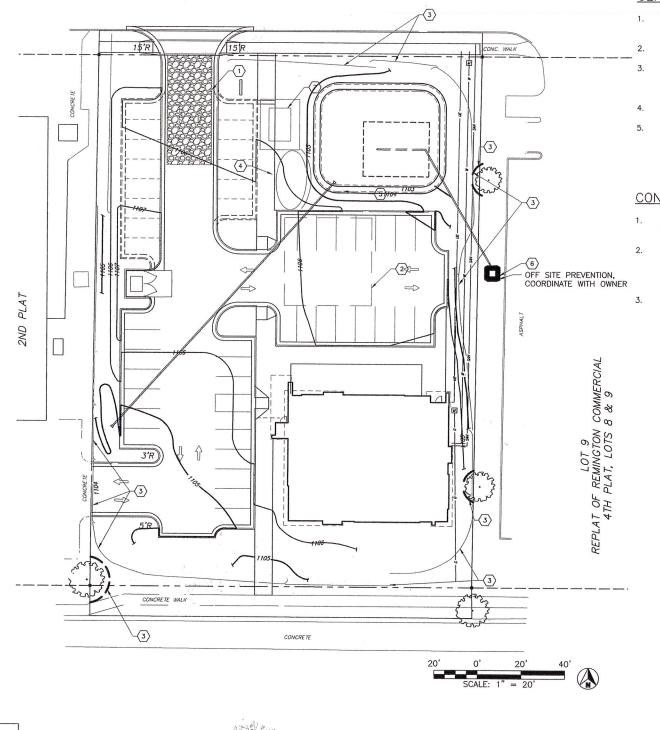

## TREE TRUNK ORANGE CONSTRUCTION FENCE POSTS 1½"X1½"X 10" OR EQUAL 6'-0" O.C.-EXTEND STAKES TO ALT. INSIDE TO OUTSIDE OF CONST. 4'-0" - EXISTING GRADE CONSTRUCTION FENCE BURIAL OF OVERALL POST 3' MIN. **PLAN**

SECTION

TREE PRESERVATION DETAIL

FENCE MAY NOT NEED TO FULLY ENCIRCLE TREE.
SEE PLAN FOR REQUIRED LOCATIONS.

#### GENERAL INFORMATION

- THE PROPERTY CONSIST OF ARISBURG SILT LOAM. INFORMATION SOURCE: NRCS SOIL SURVEY.
- NO APPARENT WETLANDS EXIST ON
- NO REGULATORY 100YR FLOOD PLAINS ARE LOCATED ON THE PROPERTY AS DETERMINED BY THE FEMA FLOOD MAP FOR THIS SITE NO STREAM CORRIDORS ARE PRESENT
- ON THE SITE. DISTURBED AREA IS 0.86 ACRES.

### CONSTRUCTION NOTES

- PRIOR TO ANY SITEWORK EROSION CONTROL MUST BE INSTALLED.
- ALL WORK SHALL BE IN ACCORDANCE WITH APWA SECTION 2150 EROSION AND SEDIMENT
- ALL RADII SHOWN ARE MEASURED A THE BACK OF CURB.



NC. 156 L ENGINEERING, I 21 W. 83rd Street, Suite 11 Prairie Village, Kansas (913) 385-2670

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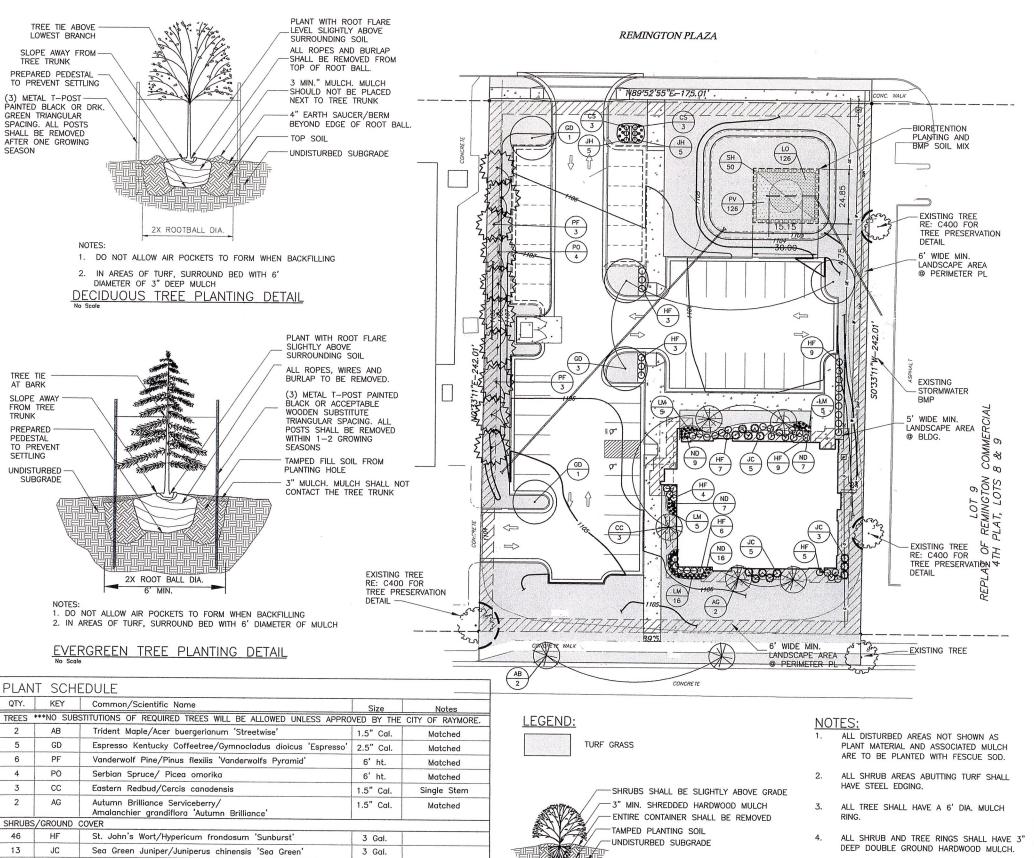
CENTER VISION

ISCOVER 1

ISSUE DATE: 16 JUNE 2017 DESIGNED BY: TSU

DRAWN BY: DCC CHECKED BY: TSU EROSION CONTROL PLAN

SHEET NUMBER C400



2X ROOT BALL DIA. MIN.

MAKE SURE ROOTS DO NOT DRY OUT DURING INSTALLATION

SHRUB PLANTING DETAIL

SOAK GENEROUSLY TO COMPACT AND SETTLE

MINIMUM ROOT SPREAD TO BE IN ACCORDANCE WITH ANLA STANDARDS PRUNE DAMAGED LIMBS OR ROOTS AFTER INSTALLATION

39

31

10

83

83

50

TURF GRASS

ND

LM

CS

JH

LO

PV

SH

BIORETENTION CELL PLANTINGS

Heavenly Bamboo/Nandina domestica 'Fire Power

Kelsey's Dwarf Red-Osier dogwood/Cornus sericea 'Kelseyi

Variegated Lillyturf/Liriope muscari 'Variegata'

Rice Cutgrass/Leersia oryzoides

Prairie Dropseed/Sporobolus heterolepis

Switchgrass/Panicum virgatum

Blue Rug Juniper/Juniperous horizontalis 'Wiltoni

3 Gal.

1 Gal.

3 Gal.

3 Gal.

1 OT

1 QT

1 gal.

24" tri sp.

24" tri sp.

24' o.c.

- ALL TURF AND GRASS AREAS SHALL HAVE MIN. 4" OF TOPSOIL.
- ALL LANDSCAPE AREAS TO BE IRRIGATED WITH A FULLY AUTOMATIC IRRIGATION SYSTEM.
- ALL PLANT MATERIAL MUST CONFORM TO AMERICAN STANDARD FOR NURSERY STOCK (ANSI Z60.1).
- LEAVE TAGS ON REQUIRED PLANT MATERIAL FOR INSPECTION.

#### LANDSCAPE DEVELOPMENT DATA:

THE FOLLOWING ARE REQUIREMENTS WERE DERIVED FROM CHAPTER 430 LANDSCAPE AND SCREENING OF THE RAYMORE UNIFIED DEVELOPMENT CODE 24TH AMENDMENT DATED 2/13/2017.

#### 430.010 APPLICABILITY

A. ALL NEW STRUCTURES, BUILDINGS AND PARKING LOTS MUST COMPLY WITH THE LANDSCAPE AND SCREENING REQUIREMENTS OF THIS CHAPTER.

#### 430.020 LANDSCAPE AREA REQUIREMENTS

A. WHERE REQUIRED.

REQUIREMENT: COMMERCIAL/INDUSTRIAL = 20% MIN. (WITH 20% MAX. POROUS NON-LIVING MATERIALS)

**PROVIDED** 

42,253 SF TOTAL SITE 13,441 SF TOTAL LANDSACPE AREA = 32% LANDSCAPE AREA

=6.9% OF THE LANDSCAPE AREA IS PORUS NON-LIVING MATERIALS

#### B. PLACEMENT OF LANDSCAPE AREA.

B.1. REQUIREMENT: 6' WIDE ALONG STREET FRONTAGES. (SEE PLAN) B.2. REQUIREMENT: 6' WIDE ALONG PERIMETER PROPERTY LINES. (SEE

#### C. FOUNDATION LANDSCAPING.

REQUIREMENT: 5' WIDE MINIMUM ALONG THE FOUNDATION OF ALL BUILDINGS. (SEE PLAN)

#### 430.030 PARKING AREA LANDSCAPING

A.1 INTERIOR PARKING LOT LANDSCAPING 1 SHADE TREE PER 10 PARKING SPACES

#### 3 SHRUBS PER 10 PARKING SPACES

REQUIRED:

BASE 32 PKG SPACES = 4 TREES = 10 SHRUBS

ALTERNATE 46 PKG SPACES = 5 TREES

PROVIDED: 5 TREES & 13 SHRUBS

A.2. LANDSCAPE ISLANDS 8' WIDE & 128 SF MIN.

#### B. PERIMETER PARKING LOT LANDSCAPING

B.1. APPLICABILITY. ALL NEW OFF-STREET PARKING MUST INSTALL PERIMETER PARKING LOT LANDSCAPING.

- B.2. PARKING AREAS ABUTTING RESIDENTIAL DISTRICTS. DOES NOT APPLY.
- B.3. PARKING AREAS ABUTTING PUBLIC STREETS, DOES NOT APPLY.
- B.3.a. MAINTAIN A 6' LANDSCAPE STRIP THE LENGTH OF THE R.O.W. + ONE SHADE TREE PER 40 LF ALONG THE PARKING. DOES NOT APPLY.

B.3.b. DOES NOT APPLY.

SECTION 430.040 LOADING AREAS - DOES NOT APPLY

SECTION 430.050 3' WIDE MIN. LANDSCAPE AREA AROUND MONUMENT

SECTION 430.060 SITE TREES - DOES NOT APPLY

#### SECTION 430.070 STREET TREES

REMINGTON PLAZA IS NOT DESIGNATED AS A GREENWAY.

FOXWOOD SPRINGS DRIVE IS DESIGNATED AS A GREENWAY.


REQUIRED: 1 TREE PER 50 LF (EXCLUDING DRIVEWAYS) TREES TO BE LOCATED IN THE R.O.W.

=175' FRONTAGE ALONG FOXWOOD SPRINGS DRIVE

=175/50= 3 TREES REQUIRED PROVIDED: = 3 TREES (INCLUDES 1 EXISTING)

\*\*\*NOTE: ALL TREES TO BE SELECTED FROM THE LIST OF ALLOWABLE TREE SPECIES FOR STREET TREES REFERENCED IN SECTION 430.090 AND APPROVED BY THE CITY PRIOR TO INSTALLATION.

SECTION 430.080 SCREENING REQUIREMENTS 430.080 B. SCREENING TABLE C-3 TO C-3 = "+" DESIGNATION RESULTING IN A 6' MIN. LANDSCAPE AREA REQUIRED AS IN SECTION 430.020

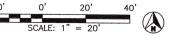

DAVID C. CAMPBELL LANDSCAPE ARCHITECT Lee's Summit, MO 816.510.8728



SC 156 ENGINEERING

4121 W. 8 HH




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ISSUE DATE: 16 JUNE 2017
DESIGNED BY: TSU
DRAWN BY: DCC

HECKED BY: TSU HEET NAME: LANDSCAPE PLAN

SHEET NUMBER

L100



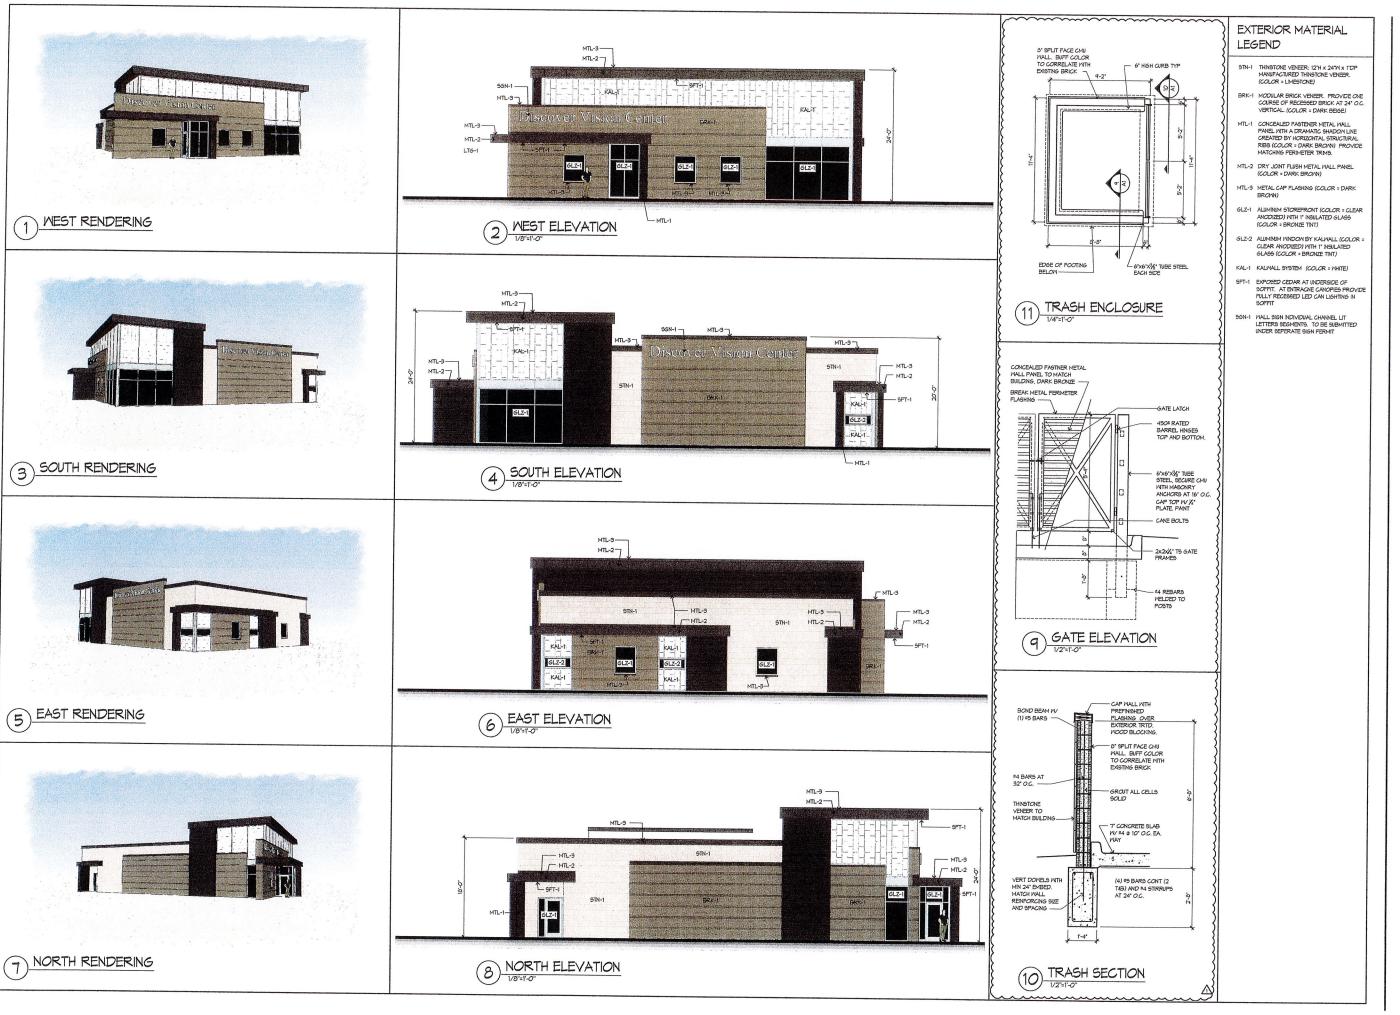

7-7-17

GUY GRONBERG
ARCHITECTS, P.C.
119 SE 344 St.
116 SE 344 NO GOOS
PROPE DISESSADDE
FOR DISESSADDE
FOR DISESSADDE




A NEW BUILDING FOR:

Discoverision.com

VISION CENTERS






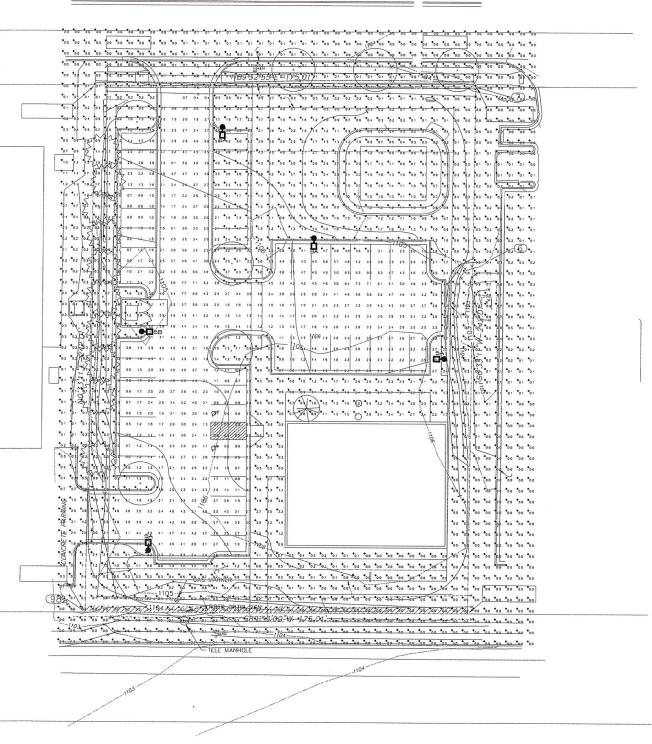



STATISTICS					
Description	Avg	Max	Min	Max/Min	Avg/Min
Parking/Drive Thru	2.7	7.7	0.4	19.3:1	6.8:1

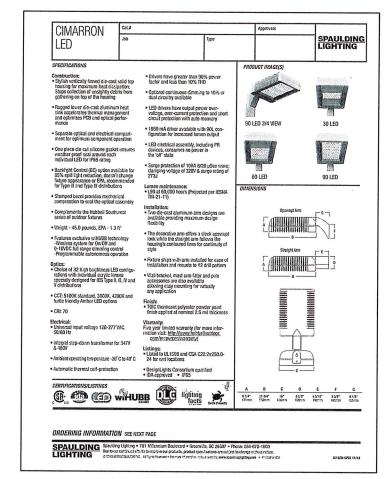


# LIGHT FIXTURE POLE SCHEDULE SPAULDING LIGHTING 555-25-40-7-A2-XX 20X4" SQUARE STRAIGHT STEEL POLE ON 2" HIGH CONCRETE BASE. VERIFY FINISH

Oppositely.

OF MIS

Darin T. Seidel

NUMBER PE-2009030047

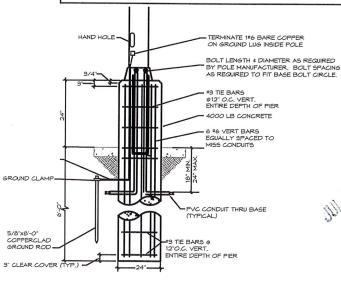

POLE FOUNDATION DETAIL



ENGINEERS NOOPPORATED 5720 Reeder Shavee, L. 66203 (913)262-1772



PE COA #2009003629



PROJECT FOR: DISCOVER VISION

ISSUE DATE:
6-15-17
REVISION:
SHEET TITLE
PHOTOMETRIC

PH1