


S8-17-D4987

1927 WEST FOXWOOD DRIVE RAYMORE, MO64083

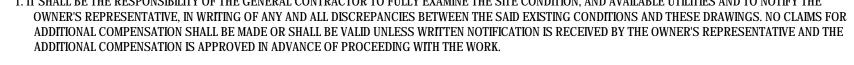

- . ALL WORK SHALL BE PERFORMED AS TO COMPLY WITH ALL GOVERNING STATUTES, ORDINANCES, REGULATIONS, CODES AND INSURANCE RATING BOARDS. NO WORK SHALL COMMENCE UNTIL ALL GOVERNMENTAL AND JURISDICTIONAL PERMITS AND APPROVALS ARE OBTAINED.

5. UNDER NO CIRCUMSTANCES SHALL THE CONTRACTOR INSTALL OR PERMIT TO BE INSTALLED, ANY MATERIALS CONTAINING ASBESTOS.

ROUGH-IN HEIGHT

STAINLESS STEEL


WASTE CLEAN OUT

STRUCTURE, STRUCTURAL

ABBREVIATIONS

Scale= NTS G-001

10. ALL WALL & CEILING CONSTRUCTION SHALL BE SUPPORTED BY STRUCTURE & NOT BY ROOF DECK IF APPLICABLE.

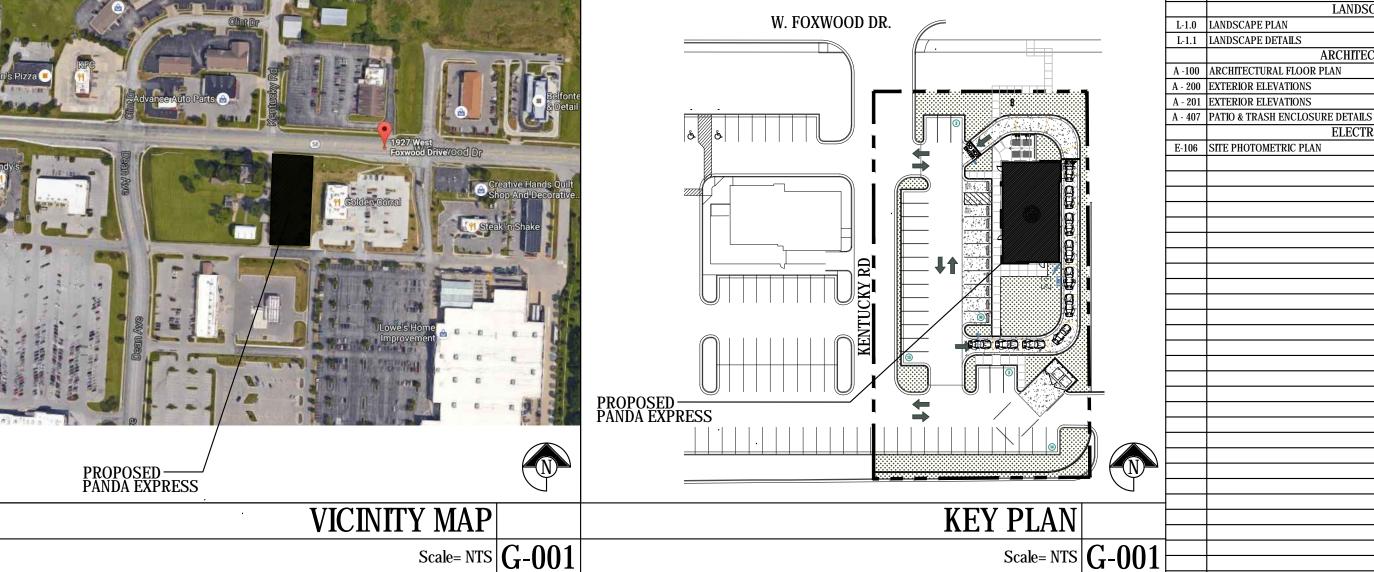

10. ALL WALL &	CEILING CONSTRUCTION SHALL BE SUPPORTED	bi Siructure & not bi roof Deci	A IF APPLICABLE.		PANDA EXP.	RESS .
			GENERAL NOTI	ES		
			Scale=	NTS G-001		
		(D1)	DOOR TYPE		APPLICABLE CODES: ALL V APPLICABLE CODES, ORDIN	
AFF	ABOVE FINISHED FLOOR		WWW.DOW.WW.DD		OF THE WORK SHALL BE PE	
ALUM.	ALUMINUM	\(\sum_{1}\)	WINDOW TYPE		CODE	
BV	BALL VALVE (FULL PORT)	TA	FLOOR FINISH		INTERNATIONAL BUILDING COD)E 9019
B.O.	BOTTOM OF	I IA	TEOOR TENESIT		INTERNATIONAL FIRE CODE 20	
C. CO	CONDUIT CONDUIT ONLY	W4>	WALL TYPE		UNIFORM MECHANICAL CODE 2	
CW	COLD WATER				UNIFORM PLUMBING CODE 201	
(E)	EXISTING	-(1)	STRUCTURAL GRID		NATIONAL ELECTRICAL CODE 2	2011
EC	ELECTRICAL CONTRACTOR				INTERNATIONAL ENERGY CONS	SERVATION
EWH	ELECTRICAL WATER HEATER	C1	CEILING FINISH		ADA / ICC/ANSI A1117 2009	
EXT.	EXTERIOR				NFPA 101 LIFE SAFETY CODE 2	2009
FOF	FACE OF FINISH	(P-C)	WALL FINISH		OCCUPANT LOA	AD CA
FOS	FACE OF STUD				INDOOR DINING	1139 S
F.S.	FLOOR SINK	34)	KITCHEN EQUIPMENT		KITCHEN	1075 S
G.C. OR GC	GENERAL CONTRACTOR				TOILET/VESTIBULE/STORAGE	240 SQ
H.W.	HOT WATER	101	ROOM NUMBER		COOLER/FREEZER ROOMS	94 SQ.
ID	INDIRECT DRAIN		MADICOL ELEVATION			TOTAL
INT.	INTERIOR	🕶	MARK OF ELEVATION			1
K.E.C.	KITCHEN EQUIP. CONTRACTOR	A/A1	0		OUTDOOR DINING	150 SQ
L.L.	LANDLORD		DETAIL			
MC	MECHANICAL CONTRACTOR	1				TOTAL
(N)	NEW	1/1.00	INT. ELEVS		BUILDING CODE	- A NI A
NIC	NOT IN CONTRACT	1/A-2.0	IVI. ELEVO			
NTS	NOT TO SCALE	A	SECTION		OCCUPANCY CLASSIFICATION TYPE OF CONSTRUCTION	
OA O.C	OUTSIDE AIR	A-2.0	SECTION		FIRE SPRINKLER	V-B NO S
O.C. PC	ON CENTER PLUMBING CONTRACTOR				FIRE STRINGLER	INU
RAR	RETURN AIR REGISTER					PRO
IMI	RETURN AIR REGISTER	/	NEW DOOR		HEROME.	901.6

TEMPERED GLAZING

APPLICABLE CODES: ALL WORK UNDER THIS CONTRACT SHALL COMPLY WITH APPLICABLE CODES. ORDINANCES AND REGULATIONS OF ALL GOVERNING BO		
OF THE WORK SHALL BE PROCURED AND PAID FOR BY THE CONTRACTOR INVO		
CODE	CITE INCODMATION	DANDA EVDDECC

INTERNATIONAL ENERGY CONS	ERVATION CODE, 2009	
ADA / ICC/ANSI A1117 2009	ERVATION CODE 2000	
NFPA 101 LIFE SAFETY CODE 20	009	
OCCUPANT LOA	D CALCULATION	
INDOOR DINING	1139 SQ. FT. / (15 / SQ. FT.) =	76
KITCHEN	1075 SQ. FT. / (200 / SQ. FT.) =	05
TOILET/VESTIBULE/STORAGE	240 SQ. FT. / (0 / SQ. FT.) =	00
COOLER/FREEZER ROOMS	94 SQ. FT. / (0 / SQ. FT.) =	00
	TOTAL =	<u>81</u>
OUTDOOR DINING	150 SQ. FT. / (15 / SQ. FT.) =	10
	TOTAL OCCUPANT LOAD =	91
BUILDING CODE	ANALYSIS	
OCCUPANCY CLASSIFICATION	GROUP A-2 (ASSEMBLY)	
TYPE OF CONSTRUCTION	V-B	

NO SPRINKLER

2,572 SQ. FT.

OCCUPANT LOAD

EGRESS WIDTH

REQUIRED / ALLOWED

81 X 0.2 = 16.2"

SITE INFORMATION		PANDA EXPRES	(PRESS		
SITE AREA	36,894 SQ. FT.	RESTAURANT AREA	2,572 S.F.		
LOT COVERAGE (FLOOR AREA RATIO)	0.07	EMPLOYEES	3 EMPLOYEES / SHIFT		
LANDSCAPE PROVIDED	8,892 SQ. FT.	EMPLUYEES	(2 SHIFTS PER DAY)		
PARKING PROVIDED	43	INDOOR SEATING	62		
		OUTDOOR SEATING	16		

TYPE OF OCCUPANCY	WATER CI	LOSET	<u>LAVATORY</u>		
	MALE	FEMALE	MALE	FEMALE	
RESTAURANT (A-2)	1 PER 75	1 PER 75	1 PER 200	1 PER 200	
REQUIRED	1	1	1	1	
PROVIDED	1	1	1	1	
TOTAL OCCUPANCY = 91	MA	LE =46	FEMA	LE = 46	

ARCHITECT STRUCTURAL KLOVER ARCHITECTS 10955 LOWELL AVE. SUITE 700 OVERLAND PARK, KS 66210 T: 913.649.8181

MECHANICAL, PLUMBING, ELECTRICAL ATTORNEY MARY JANE JUDY 900 W. 48TH PLACE SUITE 908

BUILDING DEPARTMENT

BUILDING INSPECTIONS

JON WOERNER

MICHAEL KRASS

BEN NOE 7780 W. 119TH ST. OVERLAND PARK, KS 66213 T: 913.322.1400 BNOE@MFEC.COM

ALEX PHELPS

F: 626.372.8288

LANDLORD

T: 816.572.4585

PANDA RESTAURANT GROUP

T: 626.799.9898 / 303.568.9523

1683 WALNUT GROVE AVE,

ROSEMEAD, CA 91770

KANSAS CITY, MO 64112

MJUDY@POISNELLI.COM

PLANNING/ZONING

100 MUNICIPAL CIRCLE

JCADORET@RAYMORE.COM

RAYMORE, MO 64083

JIM CADORET

T: 816.892.3030

MICHAEL KRASS

G-001 TITLE SHEET

C-1.0 SITE PLAN
C-1.1 FIRE EXHIBIT

C-2.0 UTILITY PLAN
C-3.0 GRADING PLAN C-4.0 EROSION CONTROL C-5.0 DRAINAGE MAP

L-1.1 LANDSCAPE DETAILS

A - 201 EXTERIOR ELEVATIONS

A -100 | ARCHITECTURAL FLOOR PLAN A - 200 EXTERIOR ELEVATIONS

BRITT, PETERS AND ASSOCIATES INC 101 W. CAMPERDOWN WAY, SUITE 601 GREENVILLE, SC 29601 T: 864.271.8869 F: 864.233.5140

CIVIL

BHC RHODES

JAY O'DELL 7101 COLLEGE BLVD. STE. 400 OVERLAND PARK, KS 66210 T: 913.488.5584 JAY.ODELL@IBHC.COM LANDSCAPE

BHC RHODES JAY O'DELL 7101 COLLEGE BLVD. STE. 400 OVERLAND PARK, KS 66210 T: 913.488.5584 JAY.ODELL@IBHC.COM

TEAM DIRECTORY Scale= NTS G-001

TELEPHONE COMPANY

T: 816.298.1196

JIM BRASHARD

T: 816.275.1336

100 MUNICIPAL CIRCLE RAYMORE, MO 64083 RAYMORE, MO 64083 T: 816.331.2377 T: 816.331.7916

PUBLIC WORKS

MICHAEL KRASS

MICHAEL KRASS

T: 816.331.2377

100 MUNICIPAL CIRCLE

RAYMORE, MO 64083

100 MUNICIPAL CIRCLE

JWOERNER@RAYMORE.COM WATER

100 MUNICIPAL CIRCLE 100 MUNICIPAL CIRCLE RAYMORE, MO 64083 RAYMORE, MO 64083 T: 816.331.2377 T: 816.331.2377

FIRE DEPARTMENT HEALTH DEPARTMENT SOUTH METRO. FIRE CASS COUNTY PUB. HEALTH DEPT. RANDY POWERS BRIAN KELLER 611 W. FOXWOOD DR. 300 S. MAIN ST. RAYMORE, MO 64083 HARRISONVILLE, MO 64701 T: 816.331.3008

GENERAL

LANDSCAPE

ARCHITECTURAL

JURISDICTIONAL AUTHORITIES

REVISIONS: ↑ CITY COMMENTS Scale= NTS G-001

PLANNING	(
†	
†	
	UE DATE: PLANNING

PANDA RESTAURANT GROUP INC

1683 Walnut Grove Ave.

Rosemead, California

Telephone: 626.799.9898

Facsimile: 626.372.8288

All ideas, designs, arrangement and plans indicated or represented by this drawing are the property of Panda

Express Inc. and were created for use on this specific project None of these ideas, designs, arrangements or plans may be

used by or disclosed to any person, firm, or corporation

without the written permission of Panda Express Inc.

DRAWN BY: VTL

ANDA PROJECT #:	S8-17-D498
RCH PRO IFCT #·	16044 007

OVERLAND PARK, KS 66210 ph: 913.649.8181 • fx: 913.649.1275


FOXWOOD AND DEAN PANDA EXPRESS

Foxwood and Dean 1927 W. Foxwood Drive Raymore, MO 64083

G-001

TITLE SHEET

CODE ANALYSIS SYMBOLS SHEET INDEX Scale= NTS G-001 Scale= NTS G-001 Scale= NTS G-001

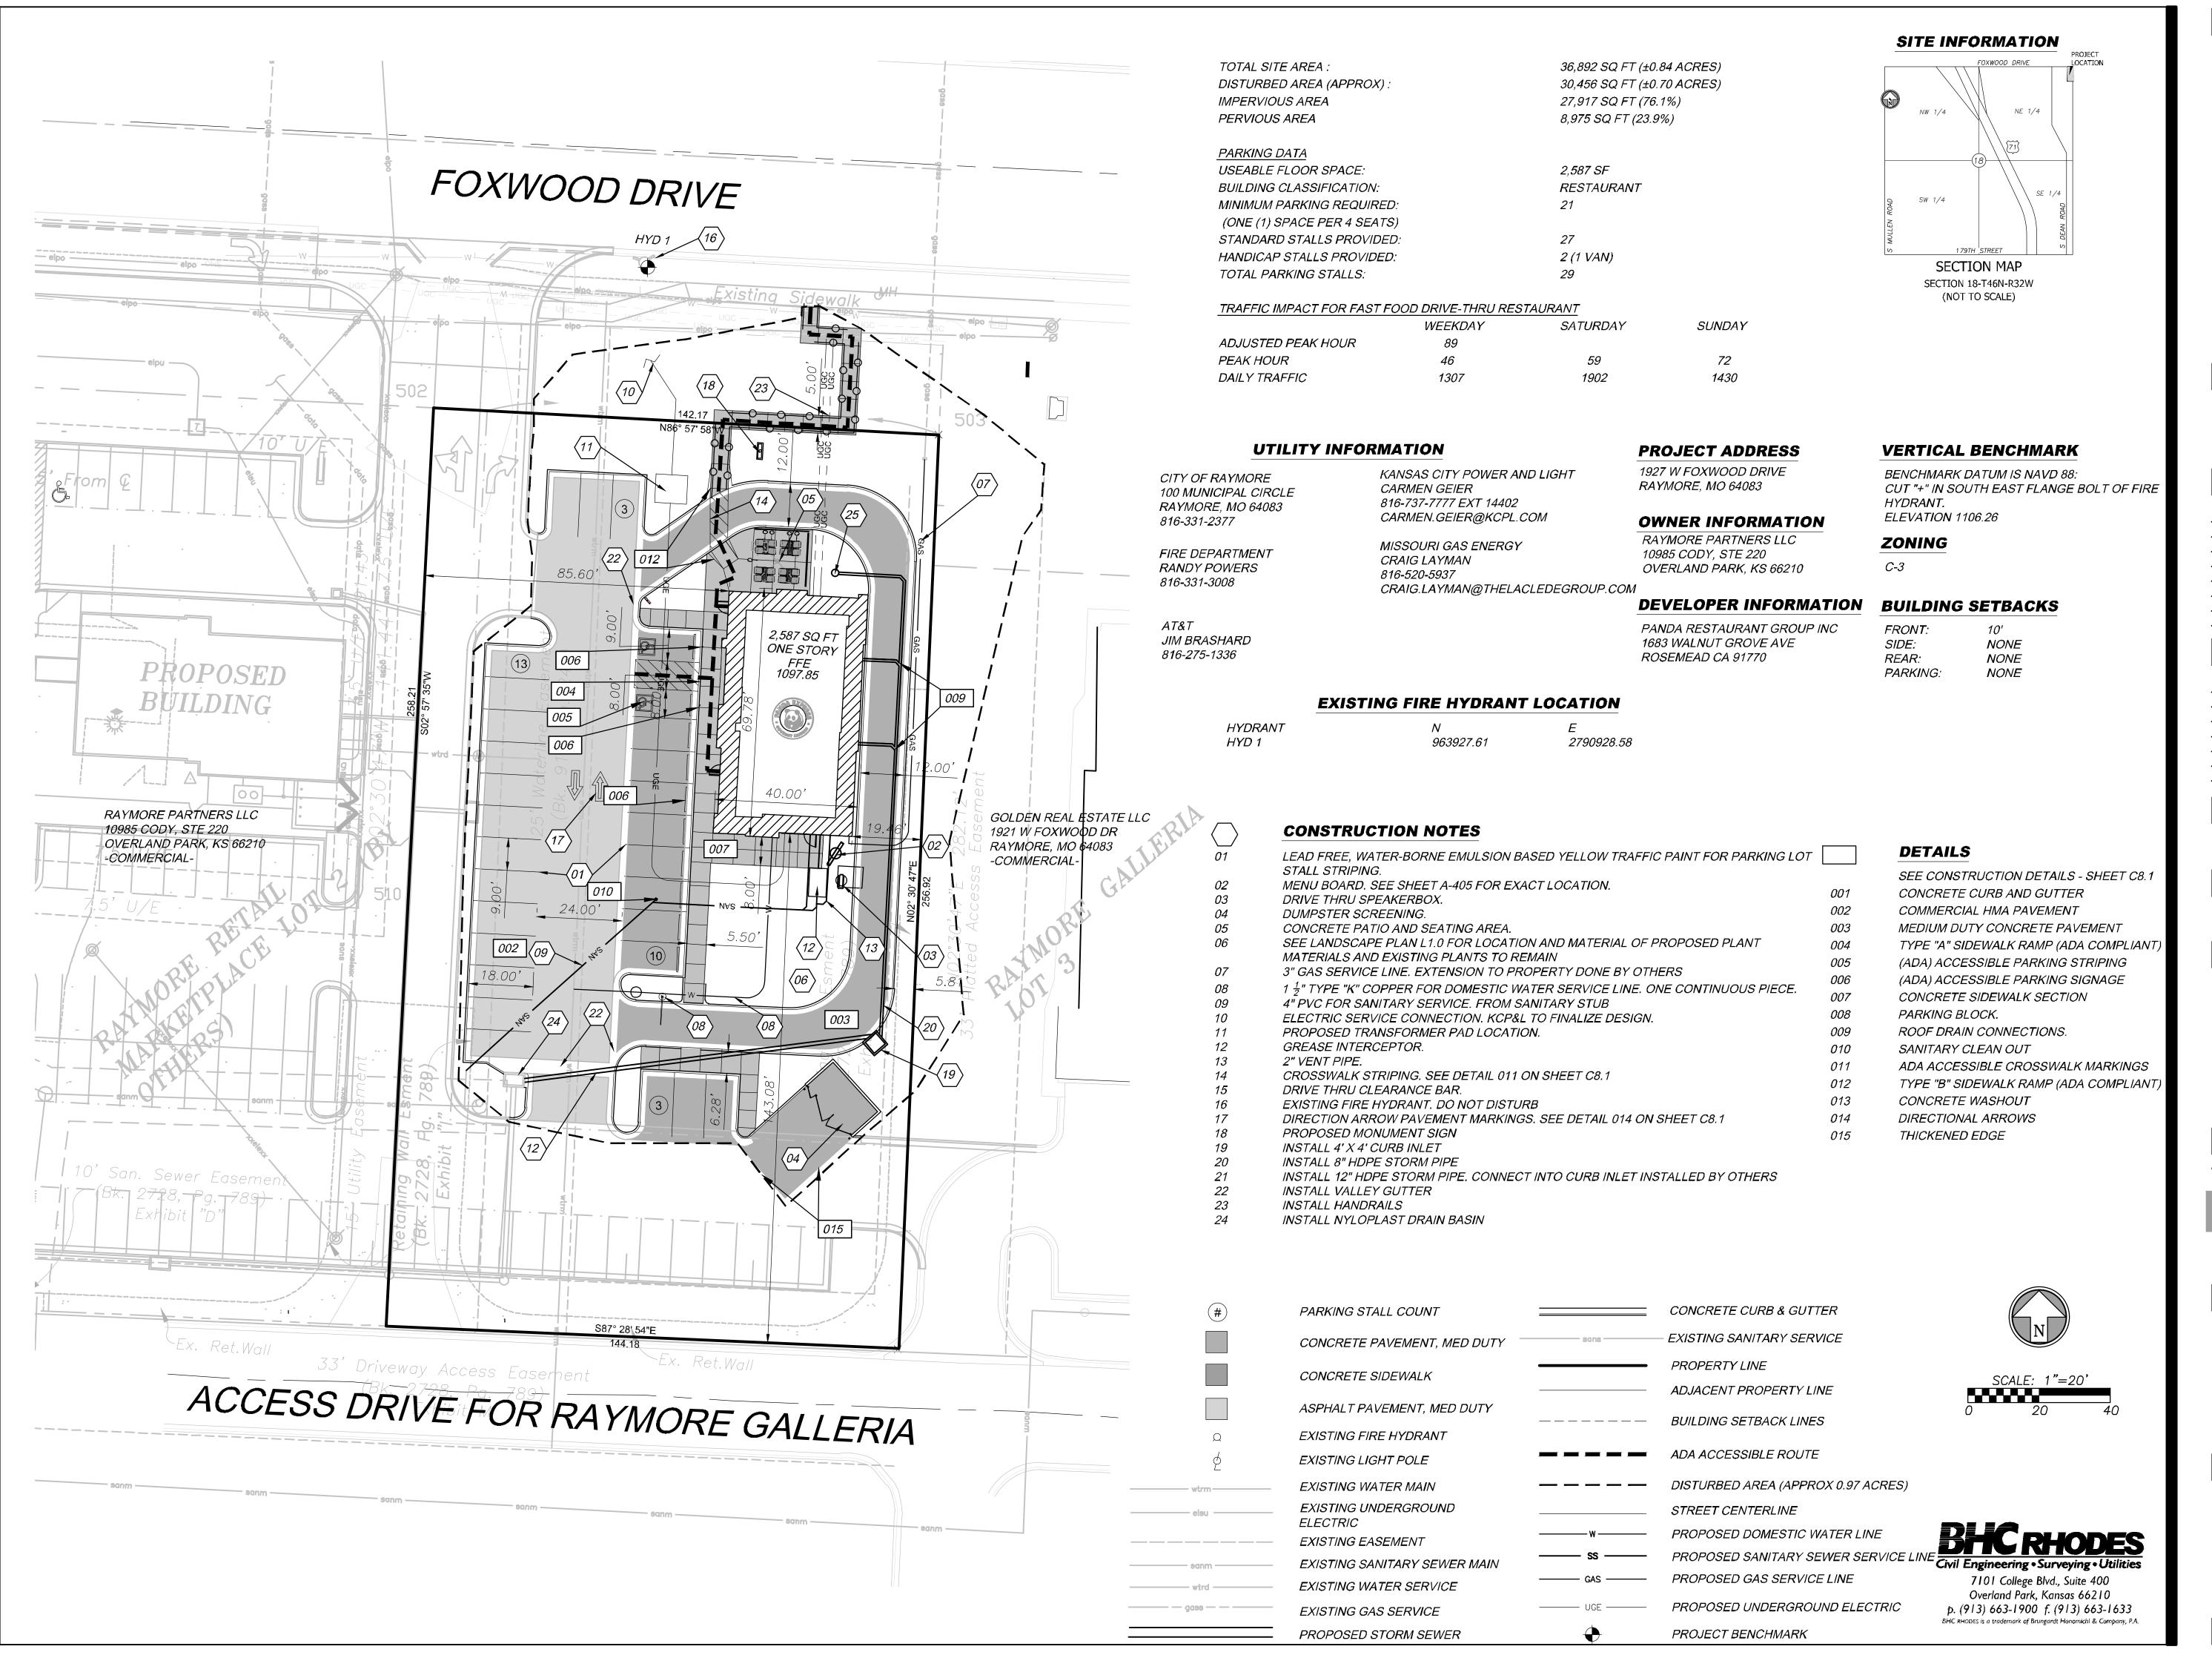



1683 Walnut Grove Ave. Rosemead, California 1770 Telephone: 626.799.9898 Facsimile: 626.372.8288

All ideas, designs, arrangement and plans indicated or represented by this drawing are the property of Panda Express Inc. and were created for use on this specific project. None of these ideas, designs, arrangements or plans may be used by or disclosed to any person, firm, or corporation without the written permission of Panda Express Inc.

REV	ISIONS:	
$\overline{\Lambda}$	CITY COMMENTS	10.20.1
ISSL	JE DATE:	
1st	PLANNING	09.30.1

DRAWN BY: JDO

PANDA PROJECT #: \$8-17-D4987

ARCH PROJECT #: 16044.007

ENGINEER LICENSE #

ARCHITECT:



10955 LOWELL AVENUE, SUITE 700 OVERLAND PARK, KS 66210 ph: 913.649.8181 • fx: 913.649.1275


FOXWOOD AND DEAN PANDA EXPRESS

Foxwood and Dean 1927 W. Foxwood Drive Raymore, MO 64083

SITE PLAN

110

ANNING SUBMITTAL

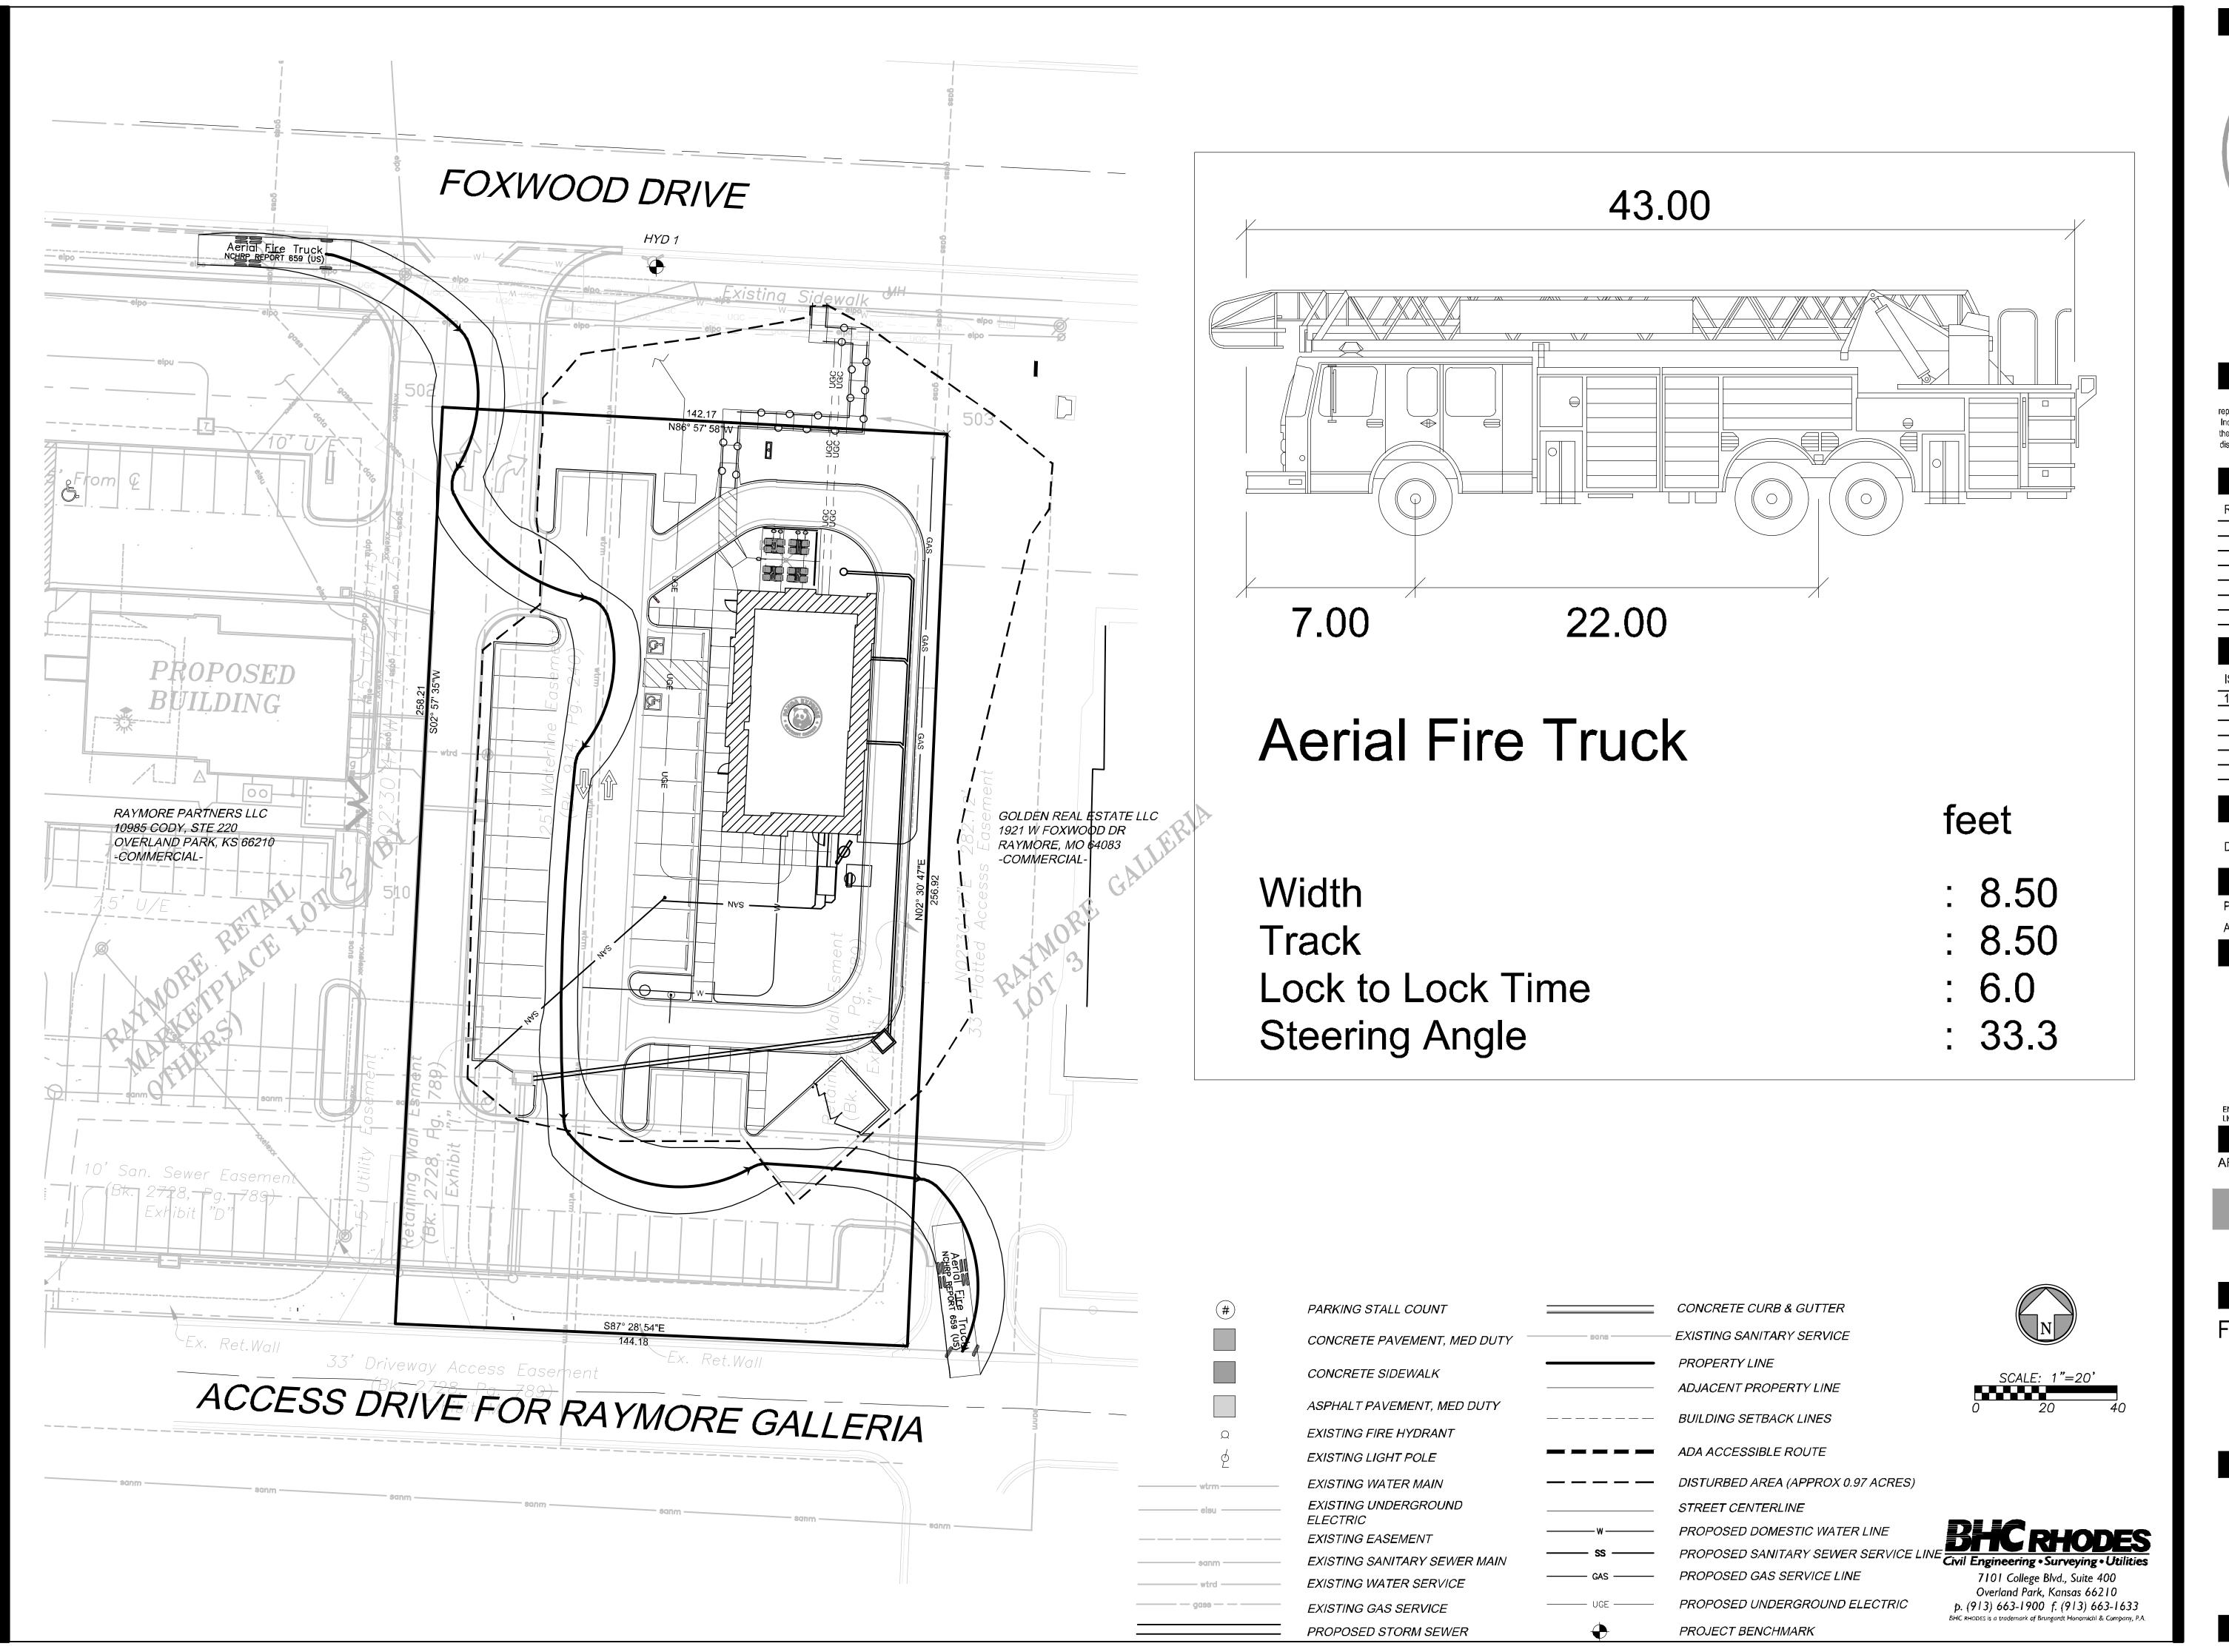



1683 Walnut Grove Ave. Rosemead, California 1770 Telephone: 626.799.9898 Facsimile: 626.372.8288

All ideas, designs, arrangement and plans indicated or represented by this drawing are the property of Panda Express Inc. and were created for use on this specific project. None of these ideas, designs, arrangements or plans may be used by or disclosed to any person, firm, or corporation without the written

PANDA PROJECT #: \$8-17-D4987
ARCH PROJECT #: 16044.007

ENGINEER LICENSE #

ARCHITECT:




10955 LOWELL AVENUE, SUITE 700 OVERLAND PARK, KS 66210 ph: 913.649.8181 • fx: 913.649.1275

FOXWOOD AND DEAN PANDA EXPRESS

Foxwood and Dean 1927 W. Foxwood Drive Raymore, MO 64083

FIRE EXHIBIT

~1 1

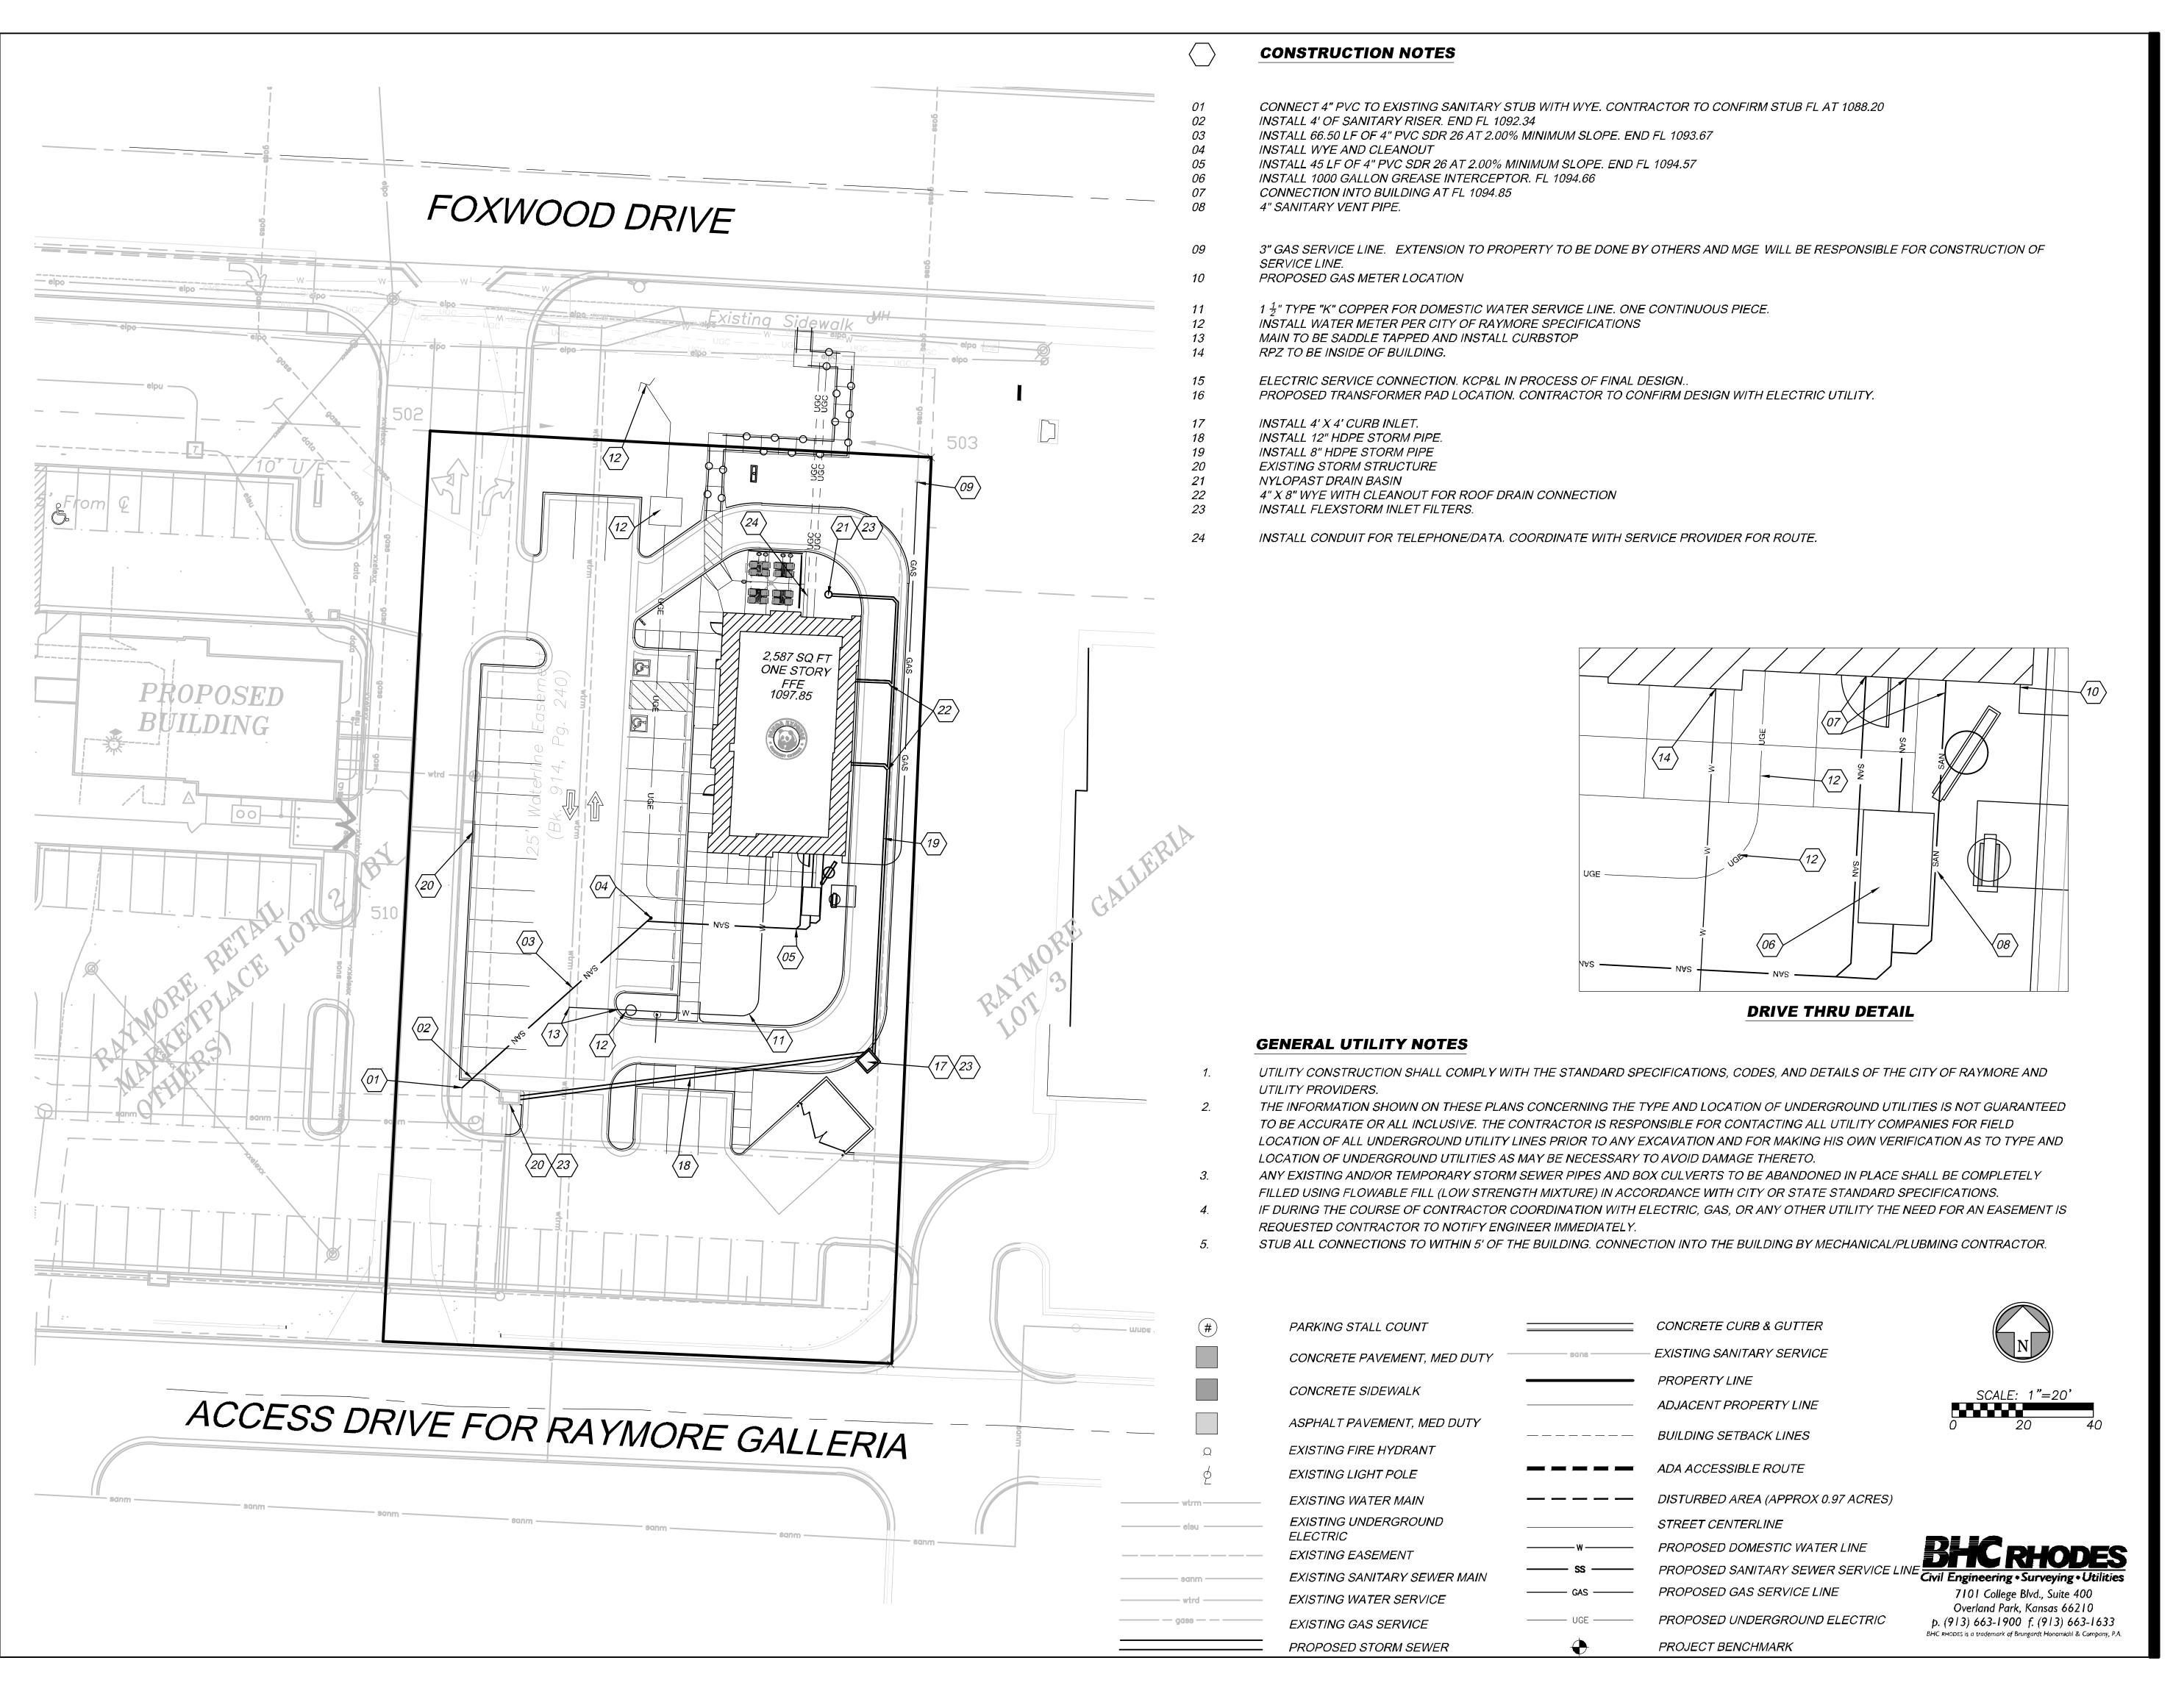



1683 Walnut Grove Ave. Rosemead, California 1770 Telephone: 626.799.9898 Facsimile: 626.372.8288

All ideas, designs, arrangement and plans indicated or

represented by this drawing are the property of Panda Express Inc. and were created for use on this specific project. None of these ideas, designs, arrangements or plans may be used by or disclosed to any person, firm, or corporation without the written permission of Panda Express Inc.

REVISIONS: ISSUE DATE:

DRAWN BY: JDO

1st PLANNING

PANDA PROJECT #: S8-17-D4987 ARCH PROJECT #: 16044.007

ENGINEER LICENSE #

ARCHITECT:




10955 LOWELL AVENUE, SUITE 700 OVERLAND PARK, KS 66210 ph: 913.649.8181 • fx: 913.649.1275

FOXWOOD AND DEAN PANDA EXPRESS

> Foxwood and Dean 1927 W. Foxwood Drive Raymore, MO 64083

UTILITY PLAN

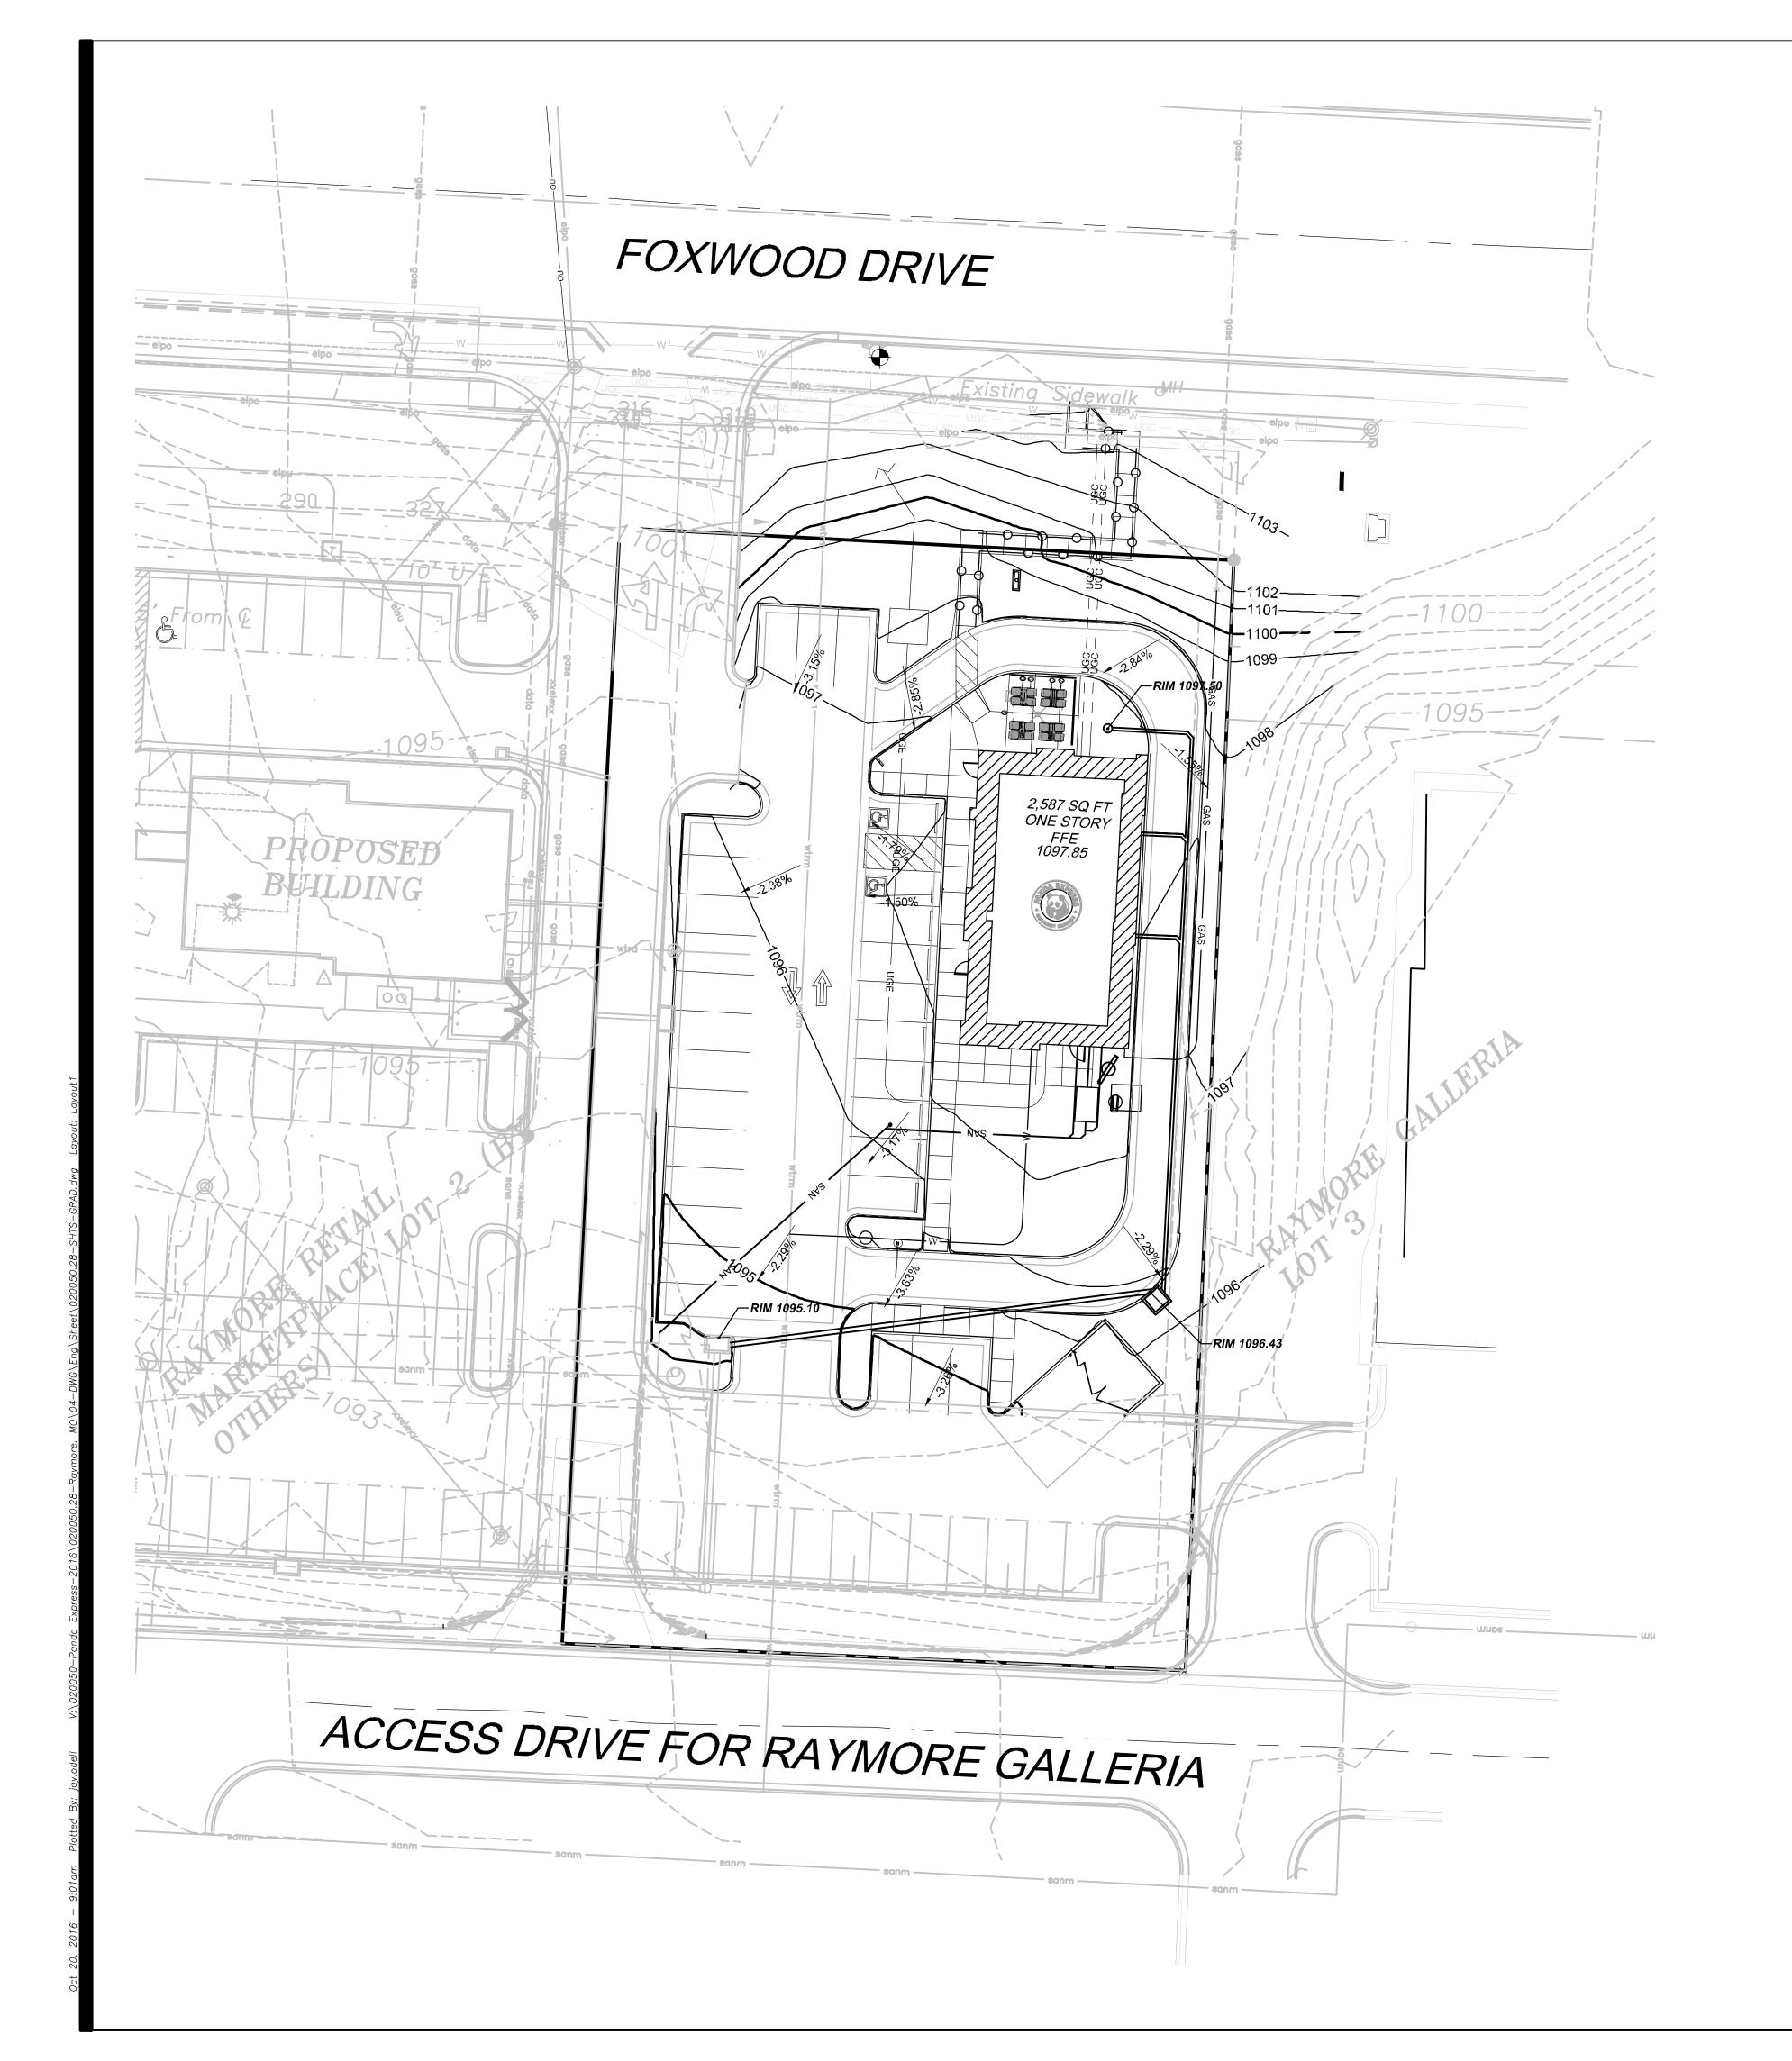

GRADING NOTES

- 1. GRADING MATERIALS AND PROCEDURES SHALL BE IN ACCORDANCE WITH CITY OF RAYMORE ENGINEERING TECHNICAL SPECIFICATIONS. ANY REQUIREMENTS SET FORTH IN THE PLANS THAT ARE IN CONFLICT WITH ANY CITY, COUNTY, OR ANY OTHER APPLICABLE JURISDICTION'S SPECIFICATIONS SHALL BE BROUGHT TO THE ATTENTION OF THE ENGINEER.
- 2. FILL MATERIALS REQUIRED FOR THIS PROJECT AND PLACEMENT OF THOSE MATERIALS SHALL BE IN ACCORDANCE WITH THE RECOMMENDATIONS SET FORTH IN THE CITY OF RAYMORE TECHNICAL SPECIFICATIONS.
- 3. FILL MATERIALS SHALL NOT BE PLACED ON FROZEN SOIL, ORGANIC MATERIALS, OR SOFT SUBGRADE.
- 4. SUBGRADE IN EXCAVATED AREAS UNDER PROPOSED PAVEMENT SHALL BE SCARIFIED AND PROPERLY COMPACTED AND MOISTURE CONDITIONED.
- 5. ALL TOPSOIL, VEGETATION, ROOT STRUCTURES, AND DELETERIOUS MATERIALS SHALL BE STRIPPED FROM THE GROUND SURFACE PRIOR TO THE PLACEMENT OF FILL MATERIALS. CONTRACTOR SHALL OBTAIN THE ACCEPTANCE OF THE ON-SITE GEOTECHNICAL REPRESENTATIVE FOR THE EXISTING GROUND SURFACE MATERIALS AND THE PROPOSED FILL MATERIAL PRIOR TO THE PLACEMENT OF FILL
- 6. ALL PROPOSED CONTOUR LINES AND SPOT ELEVATIONS SHOWN ARE FINISH GROUND ELEVATIONS. CONTRACTOR SHALL ACCOUNT FOR PAVEMENT DEPTHS, BUILDING PADS, TOPSOIL, ETC WHEN GRADING THE SITE.
- 7. ALL DISTURBED AREAS THAT ARE NOT TO BE PAVED (GREEN SPACES) SHALL BE FINISH GRADED WITH A MINIMUM OF SIX INCHES OF TOPSOIL.
- 8. ALL EXCAVATION AND EMBANKMENTS SHALL COMPLY WITH THE REQUIREMENTS OF THE CITY OF RAYMORE ENGINEERING TECHNICAL SPECIFICATIONS.
- 9. PRIOR TO PLACING ANY CONCRETE OR ASPHALT PAVEMENT THE CONTRACTOR SHALL PERFORM A PROOF ROLL OF THE PAVEMENT SUB-GRADE WITH A FULLY LOADED TANDEM AXLE DUMP TRUCK. THE PROOF ROLL SHALL BE CONDUCTED IN THE PRESENCE OF THE ENGINEER AND/OR THE ON-SITE GEOTECHNICAL REPRESENTATIVE. AREAS THAT DISPLAY RUTTING OR PUMPING THAT ARE UNSATISFACTORY TO THE ENGINEER SHALL BE RE-WORKED AND A FOLLOW-UP PROOF ROLL SHALL BE CONDUCTED PRIOR TO ACCEPTANCE OF THE SUB-GRADE FOR PAVING. THE CONTRACTOR MAY, AT ITS OWN EXPENSE, STABILIZE THE SUB-GRADE USING CLASS C FLY ASH OR QUICKLIME OR SIMILAR MATERIAL, SUBJECT TO THE APPROVAL OF THE ENGINEER.
- 10. FINISHED GRADES SHALL NOT BE STEEPER THAN 3:1.
- 11. ALL GRADING WORK SHALL BE CONSIDERED UNCLASSIFIED. NO ADDITIONAL PAYMENTS SHALL BE MADE FOR ROCK EXCAVATION. CONTRACTOR SHALL SATISFY HIMSELF AS TO ANY ROCK EXCAVATION REQUIRED TO ACCOMPLISH THE IMPROVEMENTS SHOWN HEREON.
- 12. ALL AREAS ALONG ACCESSIBLE ROUTE SHOWN ON THIS PAGE SHALL COMPLY WITH 2010 ADA STANDARDS.
- 13. PAVEMENT ELEVATIONS TO BE 6" (.5') BELOW TOP OF CURB ELEVATION (TC) UNLESS OTHERWISE NOTED
- 14. CONTRACTOR RESPONSIBLE FOR FIELD VERIFYING ALL PROPOSED GRADES ENSURE POSITIVE DRAINAGE BOTH WITH PROPOSED IMPROVEMENTS AND SURROUNDING EXISTING CONDITIONS. IF ISSUE ARISES ENGINEER TO BE NOTIFIED IMMEDIATELY.


LEGEND

VERTICAL BENCHMARK

BENCHMARK DATUM IS NAVD 88: CUT "+" IN SOUTH EAST FLANGE BOLT OF FIRE HYDRANT.

PROPOSED PROPERTY LINE

ELEVATION 1106.26

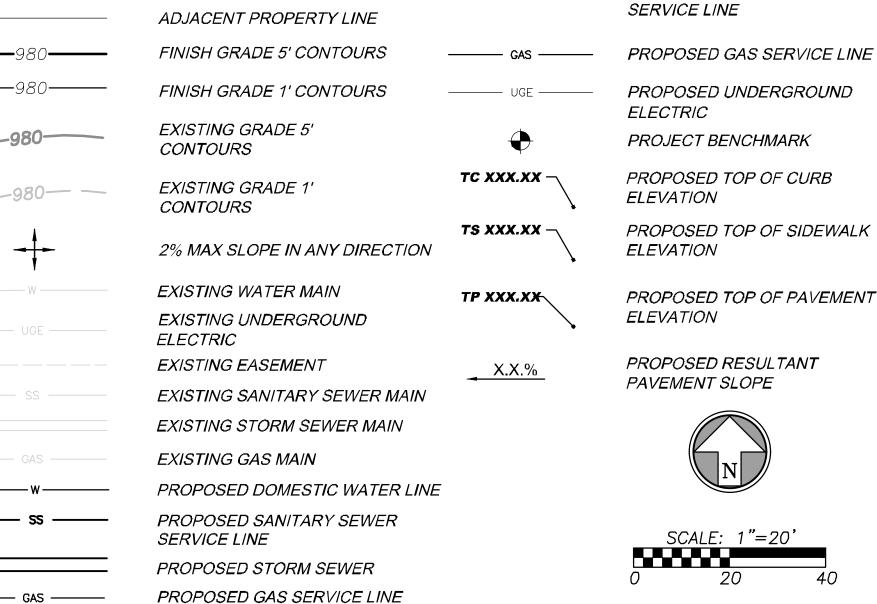

PROPOSED UNDERGROUND ELECTRIC

PROPOSED DOMESTIC WATER LINE

PROPOSED SWALE





PANDA RESTAURANT GROUP INC.

1683 Walnut Grove Ave.
Rosemead, California 1770
Telephone: 626.799.9898
Facsimile: 626.372.8288

All ideas, designs, arrangement and plans indicated or represented by this drawing are the property of Panda Express Inc. and were created for use on this specific project. None of these ideas, designs, arrangements or plans may be used by or disclosed to any person, firm, or corporation without the written

permission of Panda Express Inc.

KE'	/ISIONS:	
ISS	UE DATE:	
1st	PLANNING	09.30.

DRAWN BY: JDO

PANDA PROJECT #: \$8-17-D4987
ARCH PROJECT #: 16044.007

ENGINEER LICENSE #

PROPOSED SANITARY SEWER

Civil Engineering • Surveying • Utilities
7101 College Blvd., Suite 400
Overland Park, Kansas 66210
p. (913) 663-1900 f. (913) 663-1633
BHC RHODES is a trademark of Brungardt Honomichl & Company, P.A.

ARCHITECT:

1hckloverarchitect


10955 LOWELL AVENUE, SUITE 700 OVERLAND PARK, KS 66210 ph: 913.649.8181 • fx: 913.649.1275

FOXWOOD AND DEAN PANDA EXPRESS

Foxwood and Dean 1927 W. Foxwood Drive Raymore, MO 64083

SITE GRADING PLAN

C3.0

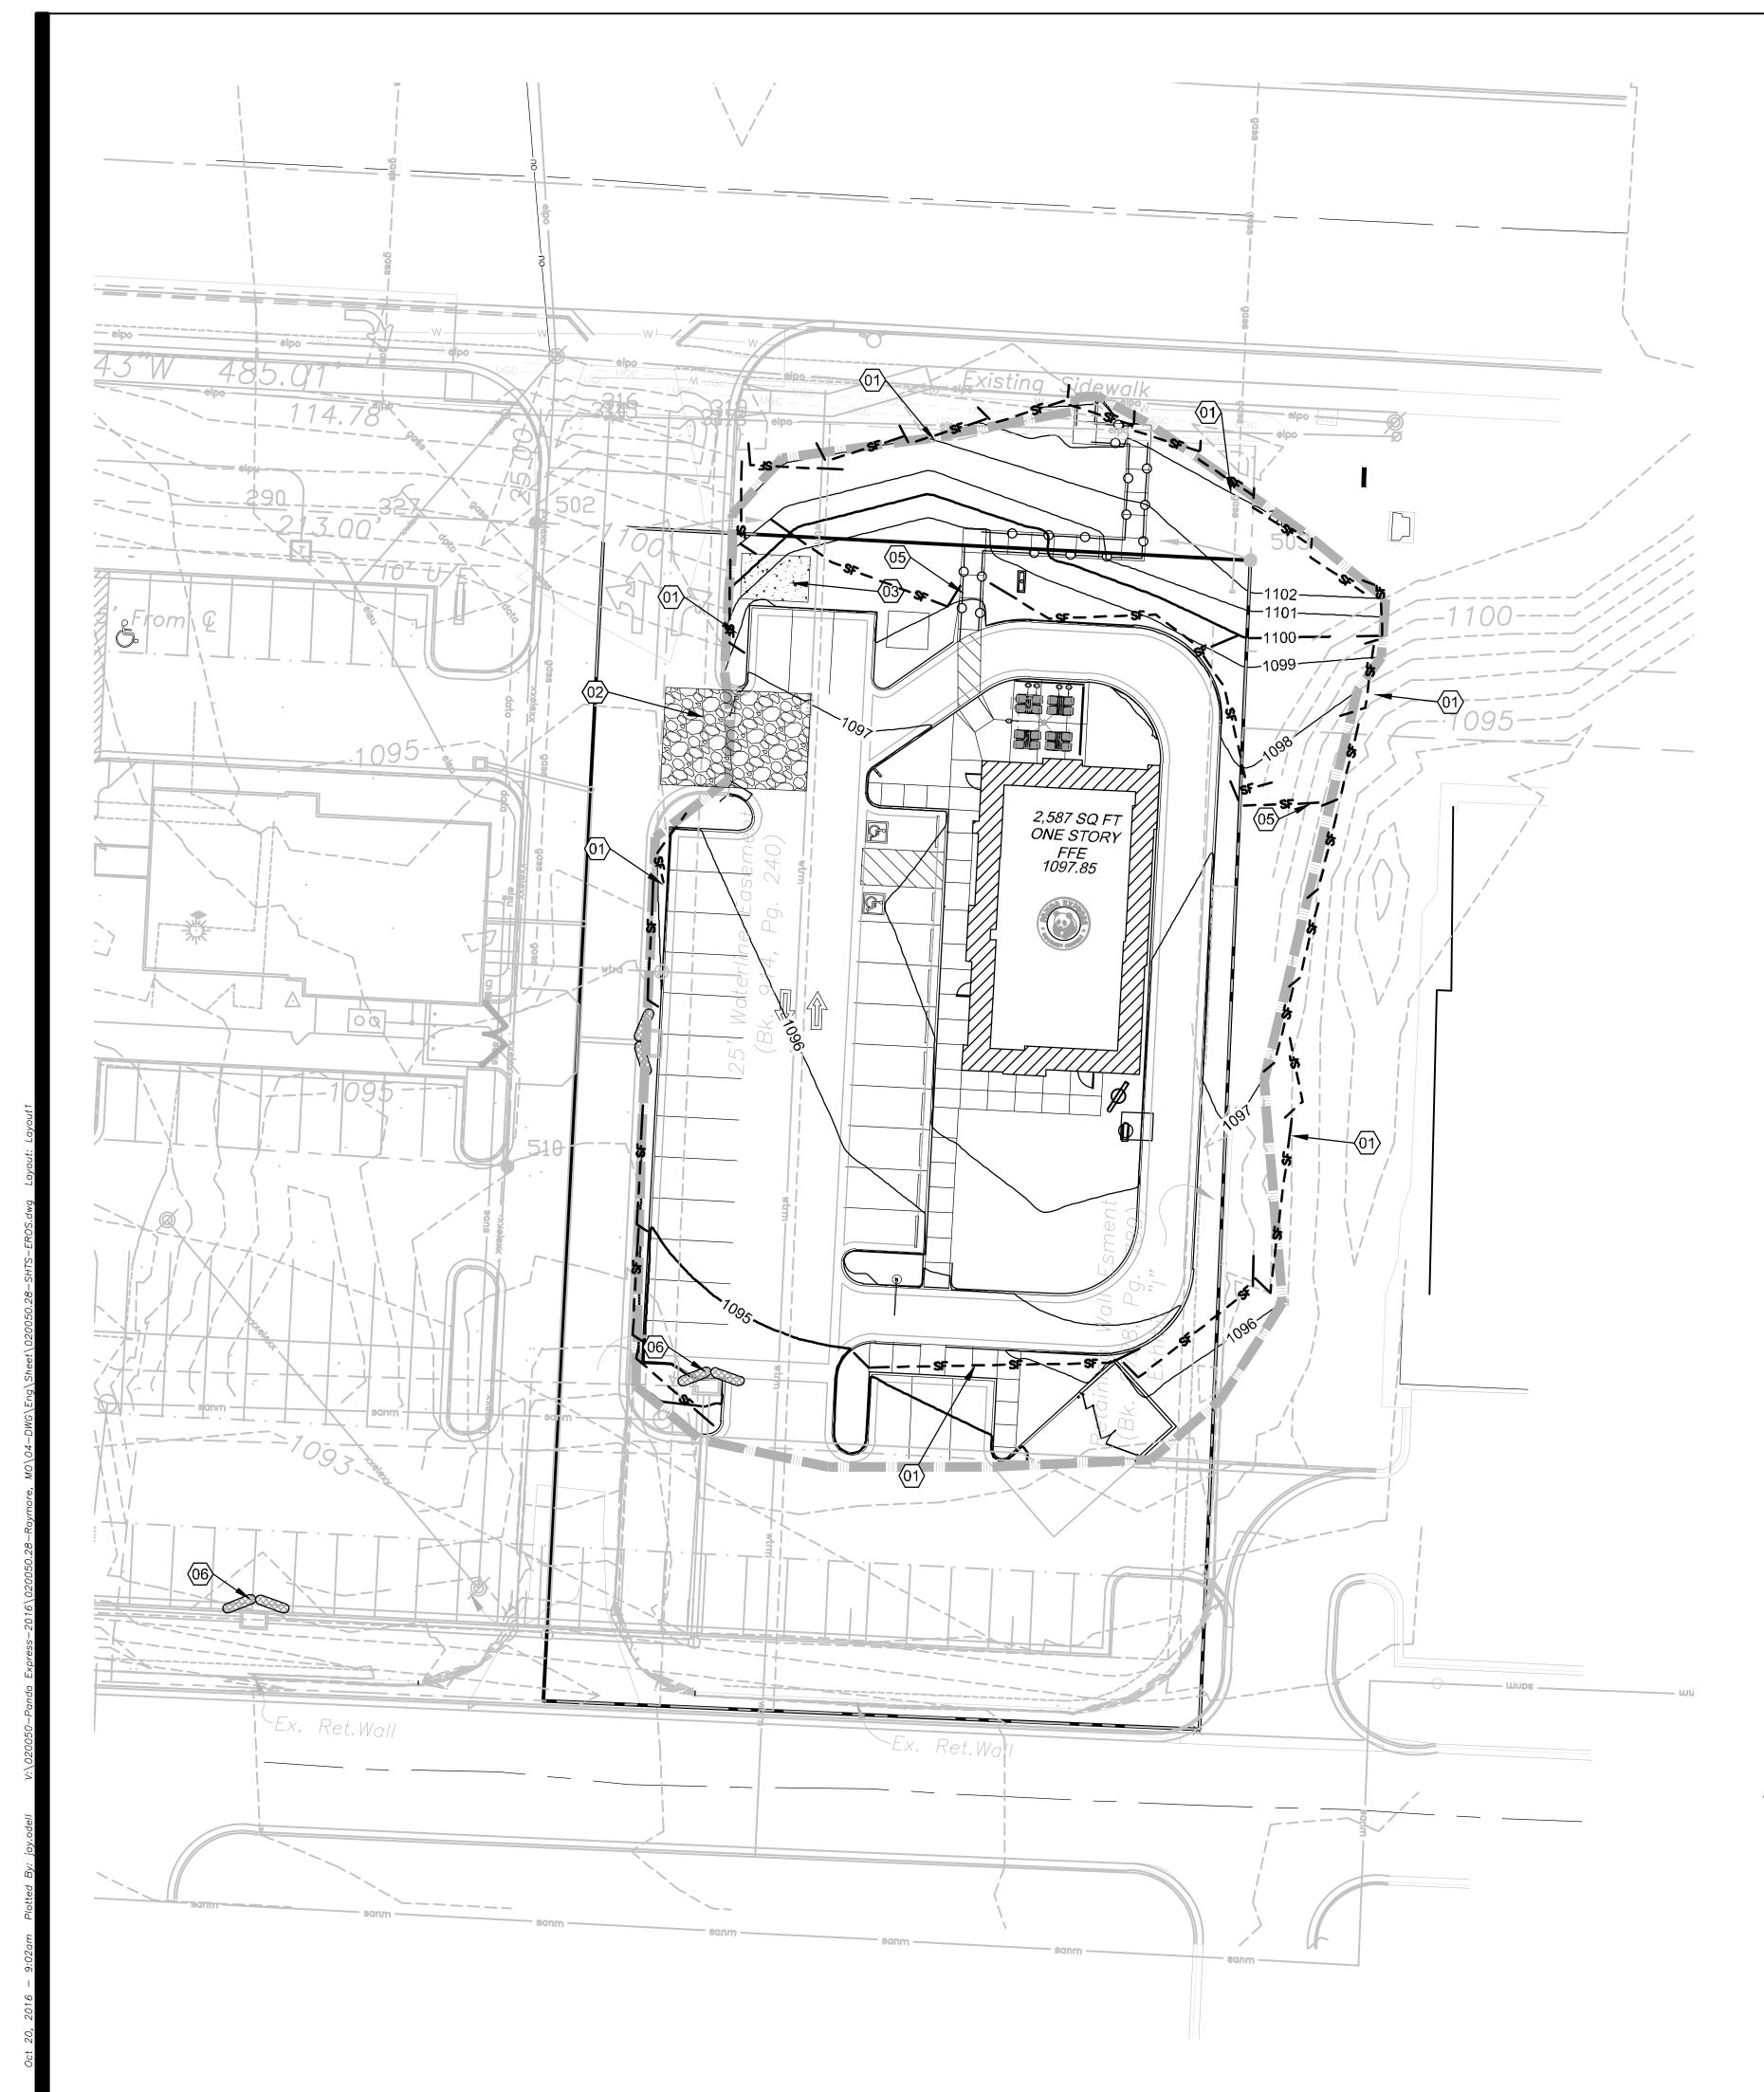

EROSION AND SEDIMENT CONTROL GENERAL NOTES

- 1. PRIOR TO LAND DISTURBANCE ACTIVITIES, THE CONTRACTOR SHALL:
- DELINEATE THE OUTER LIMITS OF ANY NATURAL STREAM CORRIDOR DESIGNATED WITH CONSTRUCTION FENCING.
- CONSTRUCT A STABILIZED ENTRANCE/PARKING/DELIVERY AREA.
- INSTALL PERIMETER CONTROLS AND REQUEST THE INSPECTION OF THE PRE-CONSTRUCTION EROSION AND SEDIMENT CONTROL MEASURES DESIGNATED ON THE APPROVED EROSION AND SEDIMENT CONTROL PLAN. LAND DISTURBANCE WORK SHALL NOT PROCEED UNTIL THERE IS A SATISFACTORY INSPECTION.
- IDENTIFY THE LIMITS OF CONSTRUCTION ON THE GROUND WITH EASILY RECOGNIZABLE INDICATIONS SUCH AS CONSTRUCTION STAKING, CONSTRUCTION FENCING, AND PLACEMENT OF PHYSICAL BARRIERS OR OTHER MEANS ACCEPTABLE TO THE INSPECTOR AND IN CONFORMANCE WITH THE EROSION AND SEDIMENT CONTROL PLAN.
- 2. THE CONTRACTOR SHALL COMPLY WITH ALL REQUIREMENTS OF THE FEDERAL CLEAN WATER ACT, MISSOURI DEPARTMENT OF NATURAL RESOURCES, AND NPDES STORMWATER RUNOFF FROM CONSTRUCTION SITES GENERAL PERMIT, INCLUDING BUT NOT LIMITED TO:
 - THE CONTRACTOR SHALL SEED, MULCH, OR OTHERWISE STABILIZE ANY DISTURBED AREA WHERE THE LAND DISTURBANCE ACTIVITY HAS CEASED FOR MORE THAN 14 DAYS.
 - THE CONTRACTOR SHALL PERFORM INSPECTIONS OF EROSION AND SEDIMENT CONTROL MEASURES AT THE FOLLOWING MINIMUM INTERVALS:
 - DURING ACTIVE CONSTRUCTION PHASES AT LEAST ONCE PER WEEK
 - DURING PERIODS OF INACTIVITY AT LEAST ONCE PER MONTH - AFTER EACH RAINFALL EVENT OF 1/2 INCH OR MORE - WITHIN 24 HOURS OF THE RAIN EVENT
 - THE CONTRACTOR SHALL MAINTAIN AN INSPECTION LOG INCLUDING THE INSPECTOR'S NAME, DATE OF INSPECTION, OBSERVATIONS AS TO THE EFFECTIVENESS OF THE EROSION AND SEDIMENT CONTROL MEASURES, ACTIONS NECESSARY TO CORRECT DEFICIENCIES, WHEN THE DEFICIENCIES WERE CORRECTED, AND THE SIGNATURE OF THE PERSON PERFORMING THE INSPECTION. THE INSPECTION LOG SHALL BE AVAILABLE FOR REVIEW BY THE REGULATORY AUTHORITY.
 - THE CONTRACTOR SHALL HAVE THE EROSION AND SEDIMENT CONTROL PLAN ROUTINELY UPDATED TO SHOW ALL CHANGES AND AMENDMENTS TO THE PLAN. A COPY OF THE EROSION AND SEDIMENT CONTROL PLAN SHALL BE KEPT ON SITE AND MADE AVAILABLE FOR REVIEW BY THE REGULATORY AUTHORITY.
- 3. PERMANENT SEEDING SHALL BE INSTALLED AFTER COMPLETION OF FINAL GRADING EXCEPT WHEN SEEDING WILL OCCUR OUTSIDE OF THE ACCEPTABLE SEEDING SEASON. WHEN TEMPORARY SEEDING IS INSTALLED, PERMANENT SEEDING SHALL BE INSTALLED AT THE NEXT SEEDING SEASON. TEMPORARY SEEDING SHALL NOT BE USED AS A STABILIZATION MEASURE FOR A PERIOD EXCEEDING 12 MONTHS. THE PERMIT WILL NOT BE CLOSED UNTIL PERMANENT SEEDING HAS BEEN ESTABLISHED TO A MINIMUM OF 70% DENSITY OVER THE ENTIRE DISTURBED AREA.
- 4. THE CONTRACTOR SHALL MAINTAIN INSTALLED EROSION AND SEDIMENT CONTROL DEVICES IN A MANNER THAT PRESERVES THEIR EFFECTIVENESS FOR PREVENTING SEDIMENT FROM LEAVING THE SITE OR ENTERING A SENSITIVE AREA SUCH AS A NATURAL STREAM CORRIDOR, AREAS OF THE SITE INTENDED TO BE LEFT UNDISTURBED, A STORM SEWER, OR AN ON-SITE DRAINAGE CHANNEL.
- 5. THE CONTRACTOR IS RESPONSIBLE FOR PROVIDING EROSION AND SEDIMENT CONTROL FOR THE DURATION OF A PROJECT. IF THE CITY DETERMINES THAT THE BMPS IN PLACE DO NOT PROVIDE ADEQUATE EROSION AND SEDIMENT CONTROL AT ANY TIME DURING THE PROJECT, THE CONTRACTOR SHALL INSTALL ADDITIONAL OR ALTERNATE MEASURES THAT PROVIDE EFFECTIVE CONTROL.
- 6. CONCRETE WASH OR RINSE WATER FROM CONCRETE MIXING EQUIPMENT, TOOLS AND/OR READY-MIX TRUCKS, TOOLS, ETC. MAY NOT BE DISCHARGED INTO OR BE ALLOWED TO RUN DIRECTLY INTO ANY EXISTING WATER BODY OR STORM INLET. ONE OR MORE LOCATIONS FOR CONCRETE WASH OUT WILL BE DESIGNATED ON SITE, SUCH THAT DISCHARGES DURING CONCRETE WASHOUT WILL BE CONTAINED IN A SMALL AREA WHERE WASTE CONCRETE CAN SOLIDIFY IN PLACE.
- 7. CHEMICALS OR MATERIALS CAPABLE OF CAUSING POLLUTION MAY ONLY BE STORED ONSITE IN THEIR ORIGINAL CONTAINER. MATERIALS STORED OUTSIDE MUST BE IN CLOSED AND SEALED WATER-PROOF CONTAINERS AND LOCATED OUTSIDE OF DRAINAGE WAYS OR AREAS SUBJECT TO FLOODING. LOCKS AND OTHER MEANS TO PREVENT OR REDUCE VANDALISM SHALL BE USED. SPILLS WILL BE REPORTED AS REQUIRED BY LAW AND IMMEDIATE ACTIONS TAKEN TO CONTAIN THEM.
- 8. SILT FENCES AND EROSION CONTROL BMPS WHICH ARE SHOWN ALONG THE BACK OF CURB MUST BE INSTALLED WITHIN TWO WEEKS OF CURB BACKFILL AND PRIOR TO PLACEMENT OF BASE ASPHALT. EXACT LOCATIONS OF THESE EROSION CONTROL METHODS MAY BE FIELD ADJUSTED TO MINIMIZE CONFLICTS WITH UTILITY CONSTRUCTION; HOWEVER, ANTICIPATED DISTURBANCE BY UTILITY CONSTRUCTION SHALL NOT DELAY INSTALLATION.
- 9. PRIVATE EROSION & SEDIMENT CONTROL INSPECTIONS ARE REQUIRED IN ACCORDANCE WITH NPDES SCHEDULE AND REQUIREMENTS. AFTER INSPECTIONS, PROVIDE THE CITY OF RAYMORE WITH REPORTS AND DOCUMENTATION.
- 10. CONTRACTOR TO COMPLETE CITY OF RAYMORE GRADING PERMIT

PROJECT STAGE	BMP PLAN REF NO.	BMP DESCRIPTION	REMOVE	NOTES:
A - PLACE BMP'S PRIOR			AFTER STAGE:	
TO LAND DISTURBANCE.	(01)	PERIMETER SILT FENCE	D	PLACE AS SHOWN ON PLAN
TO LAND DISTORDANCE.	(02)	CONSTRUCTION ENTRANCE & STAGING AREA	D	PLACE AS SHOWN ON PLAN
	(03)	CONCRETE WASH-OUT	С	PLACE AS SHOWN ON PLAN
	(04)	EXISTING INLET PROTECTION	D	INSTALL FILTER BAGS ON EXISTING INLETS
B - AFTER STRIPPING, GRUBBING, & MASS GRADING	(05)	INTERIOR SILT FENCE	D	PLACE AS SHOWN ON PLAN
C - AFTER UTILITY STORM SEWER CONSTRUCTION	(06)	STORM INLET PROTECTION	D	PLACE AS SHOWN ON PLAN
D - FINAL GRADING, PAVING & LANDSCAPING		FINAL SEEDING, SOD AND LANDSCAPING	N/A	SILT FENCING & INLET PROTECT MAY BE REMOVED ONCE SEED & SODDED AREAS ARE ESTABLISHED ON 80% OF SITE.

LEGEND


SHEET C8.1 ——— 934 ——— PROPOSED CONTOUR CONCRETE WASHOUT SHEET C8.2 ---- 934---- EXISTING CONTOUR TEMPORARY CONSTRUCTION ENTRANCE —— — — SEDIMENT FENCE SILT FENCE AREA INLET ROCK BAG PROTECTION DISTURBED AREA (0.98 AC) CURB INLET ROCK BAG PROTECTION

INLET FILTER BAGS

CONSTRUCTION ENTRANCE



CONCRETE WASHOUT

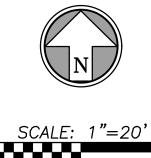

Civil Engineering • Surveying • Utilities 7101 College Blvd., Suite 400 Overland Park, Kansas 66210

DETAIL 013

DETAIL 017

DETAIL 018

DETAIL 019

DETAIL 020

p. (913) 663-1900 f. (913) 663-1633 BHC RHODES is a trademark of Brungardt Honomichl & Company, P.A.

LEGEND



PANDA RESTAURANT GROUP INC.

1683 Walnut Grove Ave. Rosemead, California 1770 Telephone: 626.799.9898

Facsimile: 626.372.8288

All ideas, designs, arrangement and plans indicated or represented by this drawing are the property of Panda Express Inc. and were created for use on this specific project. None of these ideas, designs, arrangements or plans may be used by or disclosed to any person, firm, or corporation without the written permission of Panda Express Inc.

REV	ISIONS:	
1	CITY COMMENTS	10.20.
ISSL	JE DATE:	
1st	PLANNING	09.30.

DRAWN BY: JDO

PANDA PROJECT #: S8-17-D4987 ARCH PROJECT #: 16044.007

ENGINEER

LICENSE #

ARCHITECT:




10955 LOWELL AVENUE, SUITE 700 OVERLAND PARK, KS 66210 ph: 913.649.8181 • fx: 913.649.1275

FOXWOOD AND DEAN PANDA EXPRESS

> Foxwood and Dean 1927 W. Foxwood Drive Raymore, MO 64083

EROSION CONTROL

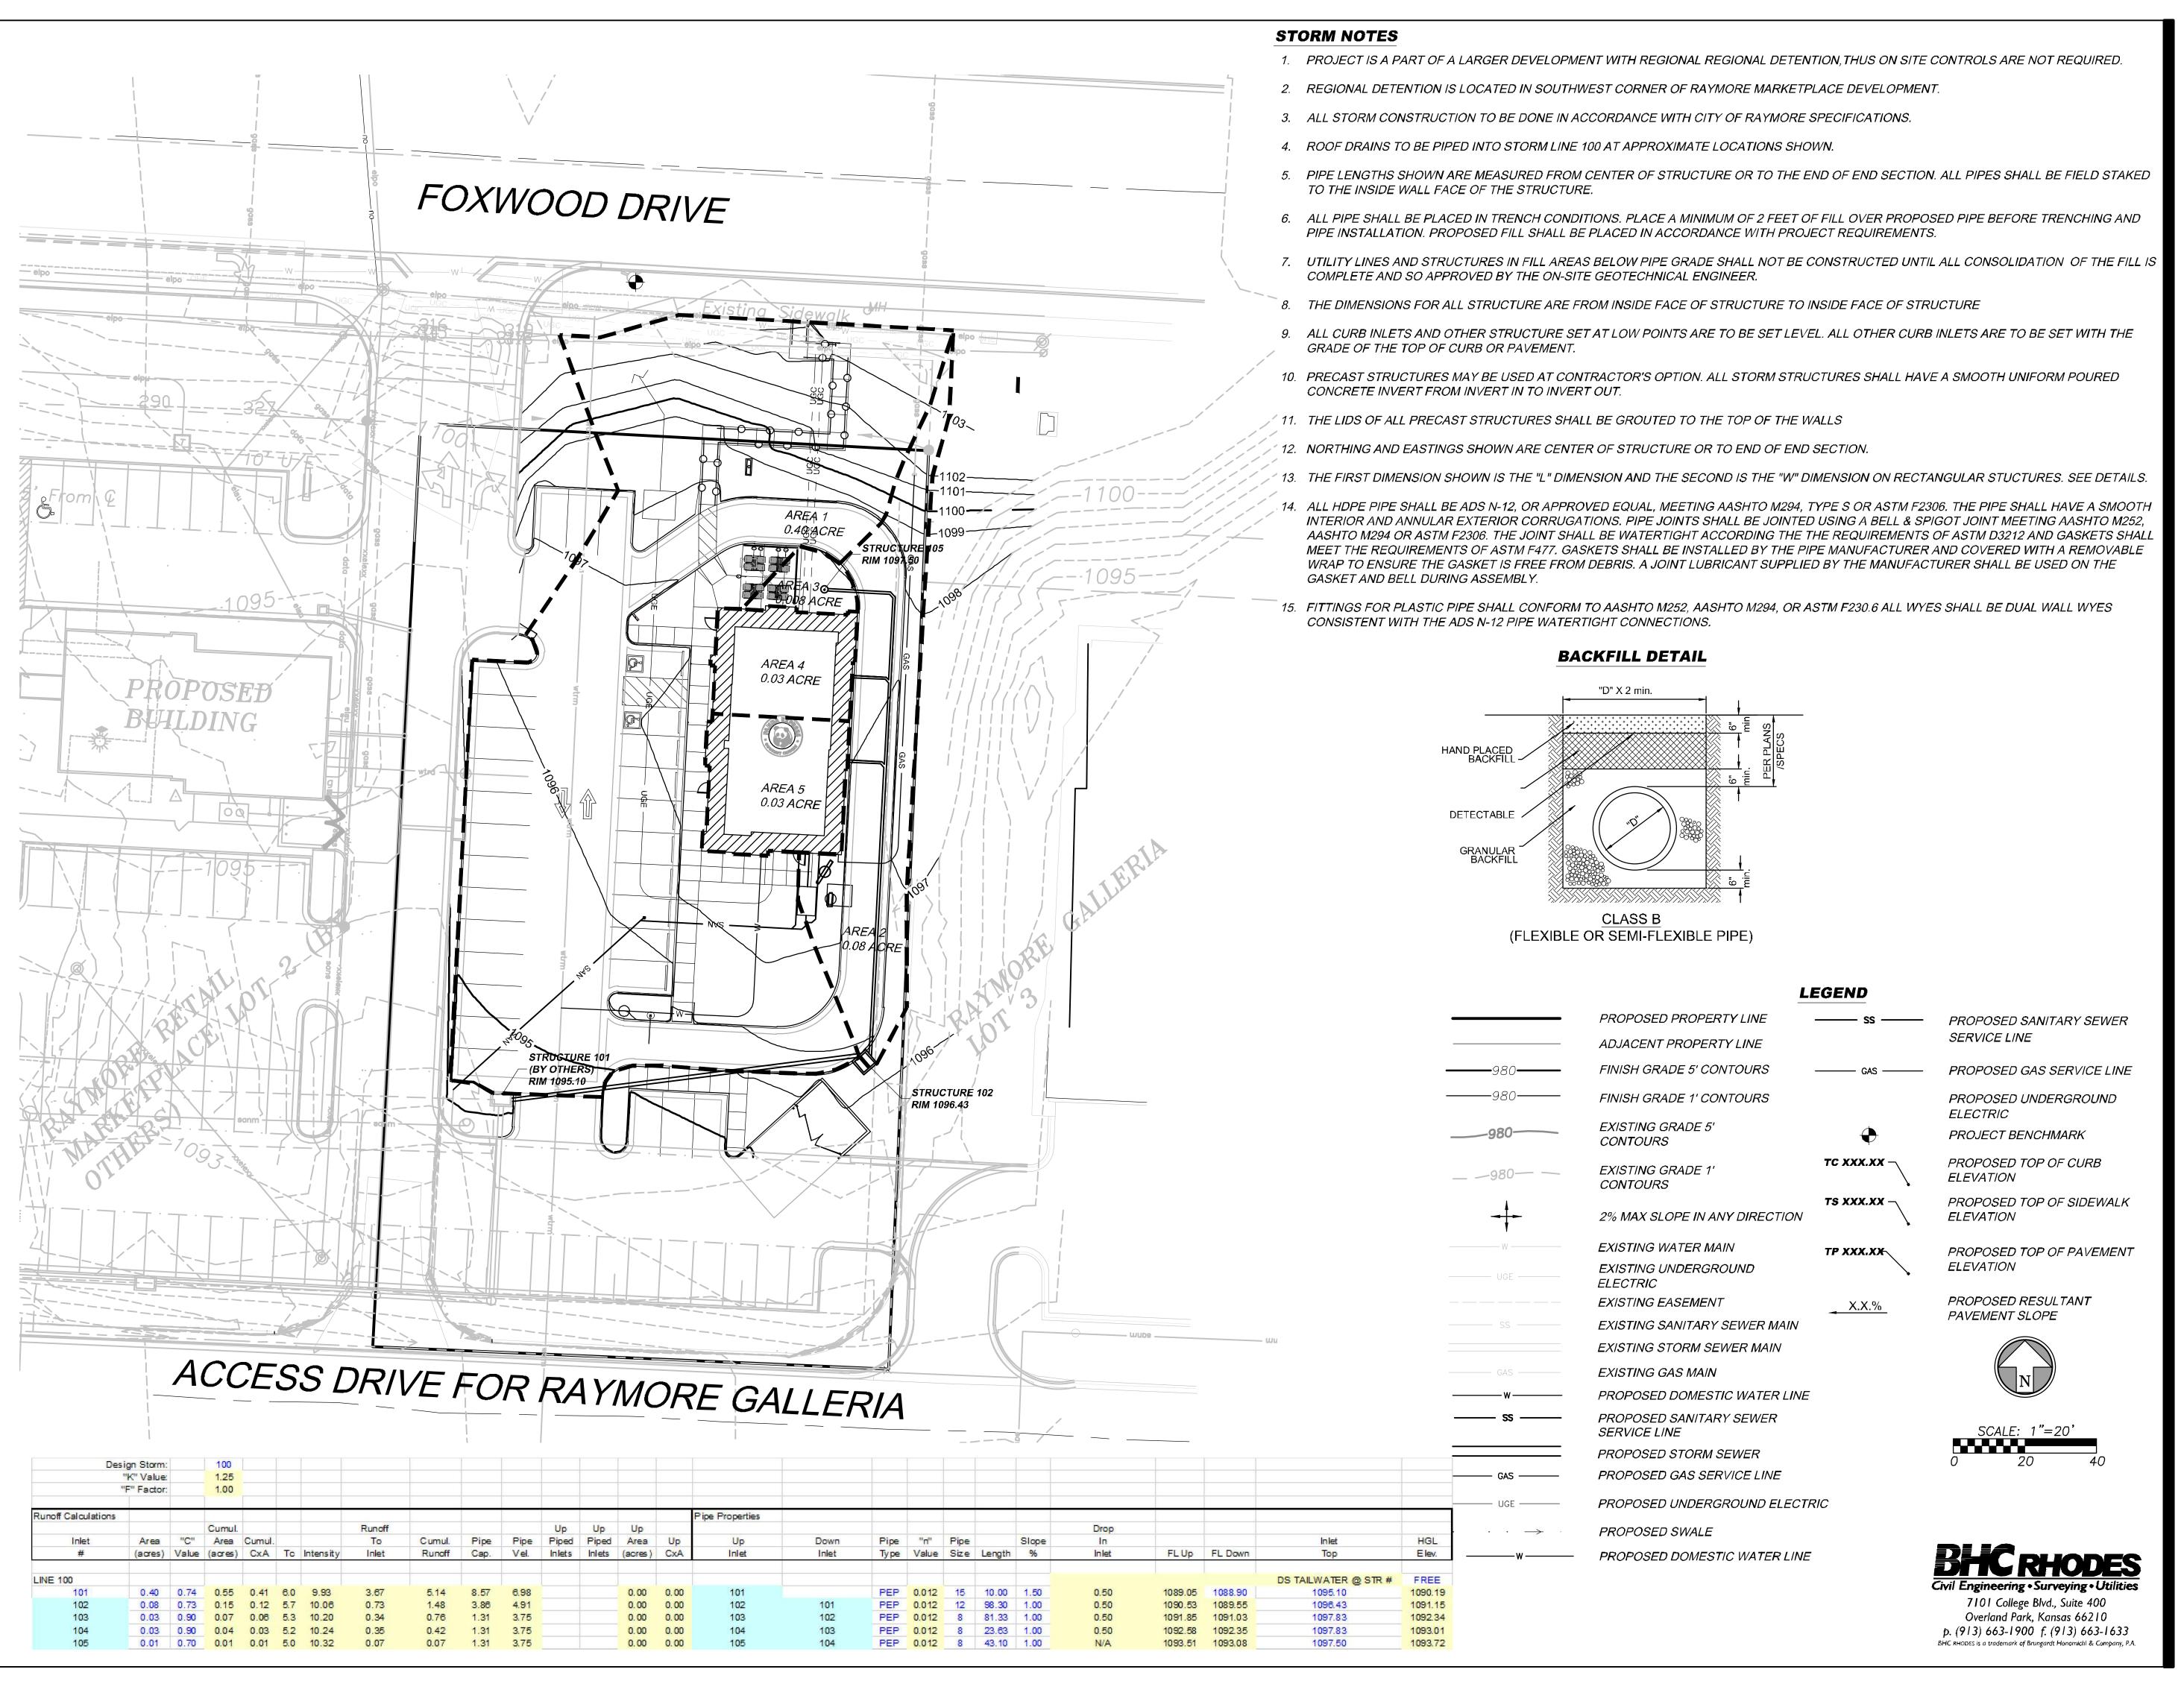



1683 Walnut Grove Ave.
Rosemead, California 1770
Telephone: 626.799.9898
Facsimile: 626.372.8288

All ideas, designs, arrangement and plans indicated or represented by this drawing are the property of Panda Express Inc. and were created for use on this specific project. None of these ideas, designs, arrangements or plans may be used by or disclosed to any person, firm, or corporation without the written permission of Panda Express Inc.

REVISIONS:

A CITY COMMENTS 10.20.16

ISSUE DATE:

1st PLANNING 09.30.16

DRAWN BY: JDO

PANDA PROJECT #: S8-17-D4987

ARCH PROJECT #: 16044.007

ARCHITECT:

ENGINEER LICENSE #

Shoklover archited

10955 LOWELL AVENUE, SUITE 700

FOXWOOD AND DEAN

PANDA EXPRESS

Foxwood and Dean


1927 W. Foxwood Drive

Raymore, MO 64083

OVERLAND PARK, KS 66210 ph: 913.649.8181 • fx: 913.649.1275

DRAINAGE MAP

C5.0

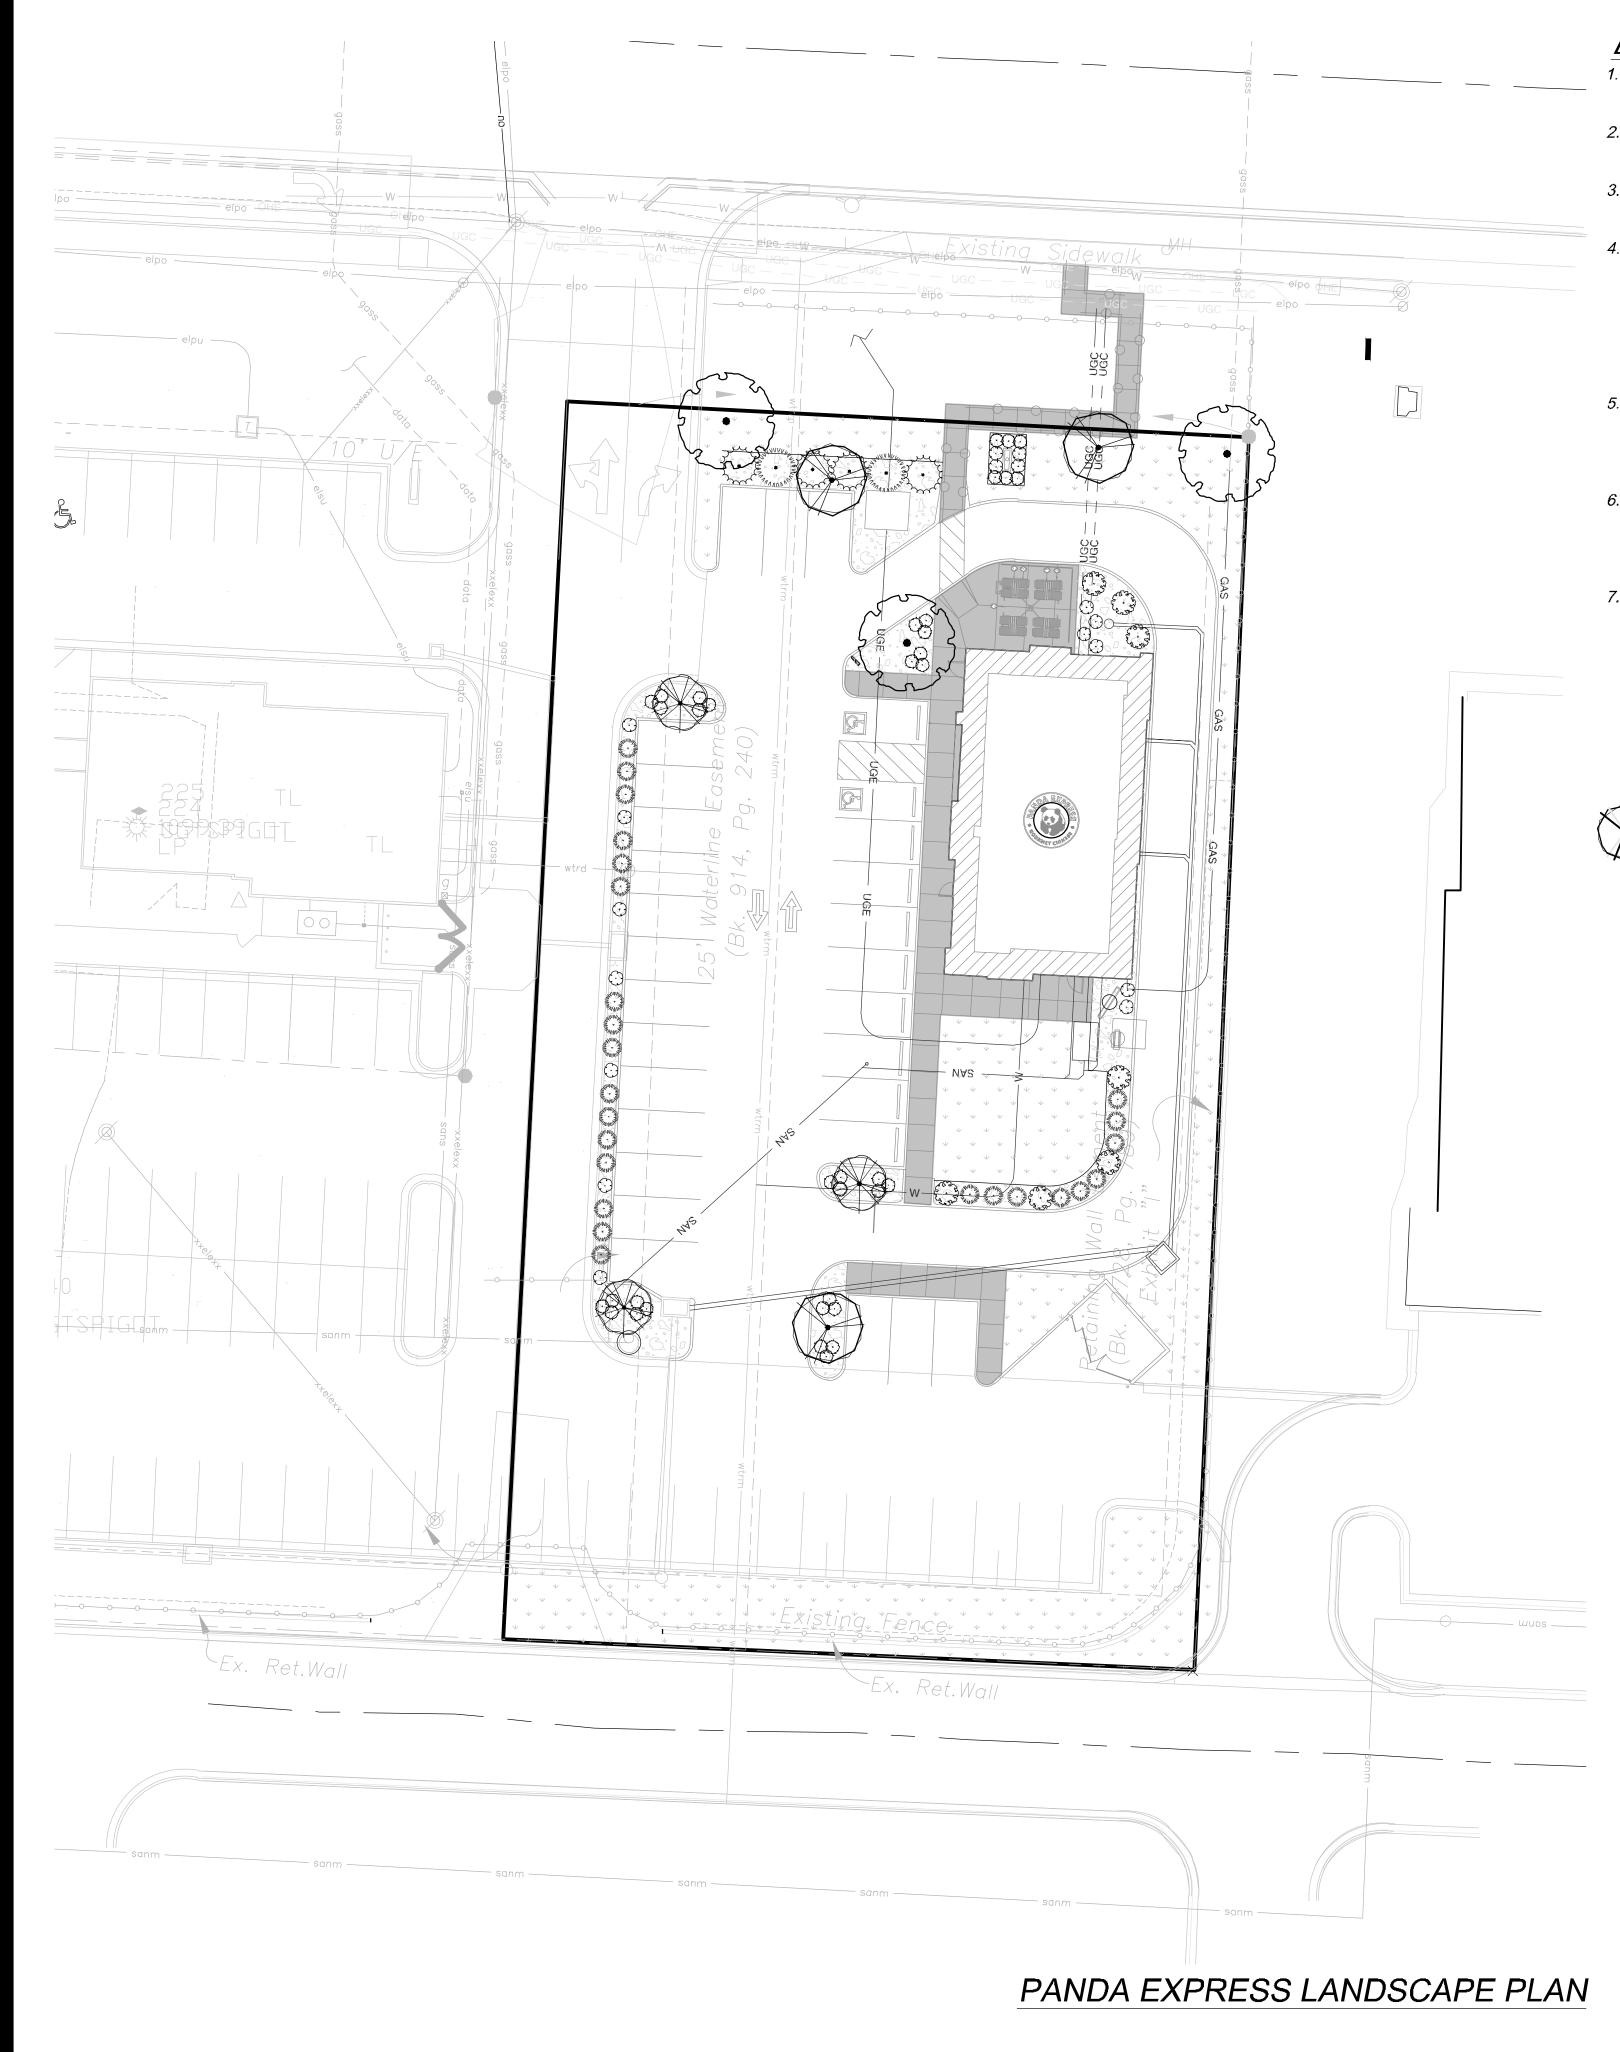

LANDSCAPING NOTES

PLANT SCHEDULE

<u>TREES</u>

- 1. ALL DISTURBED AREAS SHALL BE SODDED WITH TURF-TYPE TALL FESCUE SOD WITH A MINIMUM OF THREE CULTIVARS.
- 2. ALL LANDSCAPED AREAS SHALL RECEIVE A MINIMUM 6-INCH DEPTH OF TOPSOIL COMPACTED TO 85% DENSITY AT OPTIMUM MOISTURE CONTENT.
- 3. THE ENTIRE SURFACE TO BE LANDSCAPED SHOULD BE REASONABLE SMOOTH AND FREE FROM STONES, ROOTS OR OTHER DEBRIS.
 - SOD SHALL BE MACHINE STRIPPED AT A UNIFORM SOIL THICKNESS OF APPROXIMATELY ONE INCH (PLUS OR MINUS 1/4-INCH). THE MEASUREMENT FOR THICKNESS SHALL EXCLUDE TOP GROWTH AND THATCH. AND SHALL BE DETERMINED AT THE TIME OF CUTTING IN THE FIELD. PRECAUTIONS SHALL BE TAKEN TO PREVENT DRYING AND HEATING. SOD DAMAGED BY HEAT AND DRY CONDITIONS, AND SOT CUT MORE THAN 18 HOURS BEFORE BEING INCORPORATED INTO THE WORK SHALL NOT BE USED.
- 5. HANDLING OF SOD SHALL BE DONE IN A MANNER THAT WILL PREVENT TEARING, BREAKING, DRYING AND OTHER DAMAGE. PROTECT EXPOSED ROOTS FROM DEHYDRATION. DO NOT DELIVER MORE SOD THAN CAN BE LAID WITHIN 24 HOURS.
- 6. MOISTEN PREPARED SURFACE IMMEDIATELY PRIOR TO LAYING SOD. WATER THOROUGHLY AND ALLOW SURFACE TO DRY BEFORE INSTALLING SOD, FERTILIZE, HARROW OR RAKE FERTILIZER IN THE TIP 1-1/2-INCHES OR TOPSOIL, AT A UNIFORM RATE.
- 7. FERTILIZER SHALL BE 20-10-5 COMMERCIAL FERTILIZER OF THE GRADE, TYPE, AND FORM SPECIFIED AND SHALL COMPLY WITH THE RULES OF THE STATE DEPT. OF AGRICULTURE. FERTILIZER SHALL BE IDENTIFIED ACCORDING TO THE PERCENT N,P,K IN THAT ORDER.

BOTANICAL NAME / COMMON NAME

- SATURATE SOD WITH FINE WATER SPRAY WITHIN TWO HOURS OF PLANTING. DURING THE FIRST WEEK AFTER PLANTING, WATER DAILY OR MORE FREQUENTLY AS NECESSARY TO MAINTAIN MOIST SOIL TO A MINIMUM DEPTH OF FOUR INCHES.
- 9. A MINIMUM OF ONE MALE HOLLY WILL BE PLANTED IN EACH BED OR AS EVERY THIRD PLANT DEPENDING ON BED SIZE.
- 10. ALL PLANTING BEDS WILL BE PREPARED WITH POLYPROPYLENE LANDSCAPE FABRIC BEFORE PLANT MATERIAL IS INSTALLED. ROCK MULCH TO BE PLACED OVER POLYPROPYLENE LANDSCAPE FABRIC AT A DEPTH OF 2" - 4".
- 11. LANDSCAPE FABRIC SHOULD BE INSTALLED FLAT WITH ALL "FOLDS" EITHER PINNED DOWN WITH 4" LANDSCAPE PINS, OVERLAP ADJOINING SHEETS A MINIMUM OF 2". 4" STEEL LANDSCAPE STAPLES TO BE USED TO PIN DOWN THE CORNERS BEFORE ROCK MULCH IS INSTALLED.
- 12. CONTRACTOR SHALL PROVIDE FULL MAINTENANCE FOR NEWLY LANDSCAPED AREAS FOR A PERIOD OF 60 DAYS AFTER THE DATE OF FINAL ACCEPTANCE. AT THE END OF THE MAINTENANCE PERIOD, A HEALTHY, WELL-ROOTED, EVE-COLORED, VIABLE TURF AND LANDSCAPED AREA MUST BE ESTABLISHED. THE LANDSCAPED AREAS SHALL BE FREE OF WEEDS, OPEN JOINTS, BARE AREAS AND SURFACE IRREGULARITIES.
- 13. LANDSCAPE CONTRACTOR SHALL PROVIDE ROCK MULCH SAMPLE TO OWNER FOR APPROVAL.

CONT CAL

<u>CONT</u>

	3	Acer x freemanii 'Armstrong' / Armstrong Freeman Maple FOR PLANTING SPECIFICATIONS SEE DETAIL \$ 2, SHEET LI.I	B # B	2.5" cal
Do	3	Nyssa sylvatica 'Tupelo Tower' TM / Black Gum FOR PLANTING SPECIFICATIONS SEE DETAILS \$ 2, SHEET LI.I	B \$ B	2.5" cal
	3	Quercus x warei 'Regal Prince' / Regal Prince Oak FOR PLANTING SPECIFICATIONS SEE DETAIL \$ 2, SHEET LI.I	B # B	2.5" cal
SHRUBS	QTY	BOTANICAL NAME / COMMON NAME	CONT	
	17	Abelia x grandiflora 'Kaleidoscope' / Glossy Abelia FOR PLANTING SPECIFICATIONS SEE DETAIL 3 & 4, SHEET LI.I	5 gal	
Express of the second	36	Euonymus alatus 'Odom' TM / Little Moses Dwarf Burning Bush FOR PLANTING SPECIFICATIONS SEE DETAIL 3 & 4, SHEET LI.I	5 gal	
**************************************	4	llex verticillata / Winterberry FOR PLANTING SPECIFICATIONS SEE DETAIL 3 & 4, SHEET LO.O	5 gal	
annount the second of the seco	2	llex verticillata 'Male' / Male Winterberry FOR PLANTING SPECIFICATIONS SEE DETAIL 3 & 4, SHEET LO.O	5 gal	
	25	llex vomitoria 'Nana' / Dwarf Yaupon FOR PLANTING SPECIFICATIONS SEE DETAIL 3 & 4, SHEET LI.I	5 gal	
5 5 5 5 5 5 5 5 5 5 5 5 5 5 5 5 5 5 5	7	Viburnum trilobum 'Bailey Compact' / Bailey's Compact American Cranberry Bush FOR PLANTING SPECIFICATIONS SEE DETAIL 3 & 4, SHEET LI.I	5 gal	

Ψ Ψ Ψ Ψ	6,695 sf	Festuca arundinacea 'Watersaver Blend' / Watersaving Blend of Tall Fescue PLACE LANDSCAPE EDGING WHERE GRASS AJOINS PLANTING BEDS, SEE DETAIL 5 SHEET LI.I FOR SPECIFICATIONS	sod
<u>1ULCH</u>	QTY	COMMON NAME	<u>SIZE</u>
	22 cu. yd.	Buffalo River Rock PLACE LANDSCAPE EDGING AROUND RED PERIMETED GEE	"-3"

BOTANICAL NAME / COMMON NAME


<u> </u>	<u>aty</u>	COMMON NAME	<u>SIZE</u>	DEPTH
	22 cv. yd.	Buffalo River Rock PLACE LANDSCAPE EDGING AROUND BED PERIMETER, SEE DETAIL 5 SHEET LI.I FOR SPECIFICATIONS	"-3" stones	3" deep

SITE DATA

GROUND COVERS QTY

TOTAL SITE AREA: *36,892 SQ FT (±0..84 ACRES)* PARKING SPACES: GREEN SPACE REQUIRED: 7,378 SQ FT (20%) GREEN SPACE PROVIDED: 8,976 SQ FT (23.9%)

	REQUIRED	<u>PROVIDED</u>
STREET TREES	2.22	
1 TREE/ 50' LF	2.28	3
INTERIOR PARKING LANDSCAPING		
1 ISLAND / 10 SPACES	2.9	5
1 SHADE TREE / ISLAND	5	5
3 SHRUBS / ISLAND	<i>15</i>	<i>35</i>
PERIMETER PARKING LANDSCAPING		
1 TREE / 40' LF	1	1
BUFFER PLANTINGS	0	6
FOUNDATION PLANTING		
PLANTINGS @ 5' OC	43.2	44
MONUMENT SIGN		
PLANTINGS @ 3' OC	4.22	6

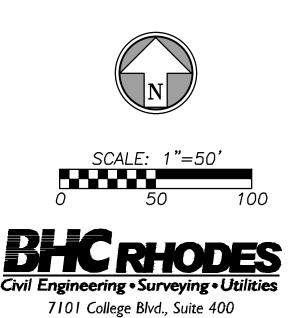

Overland Park, Kansas 66210 p. (913) 663-1900 f. (913) 663-1633 BHC RHODES is a trademark of Brungardt Honomichl & Company, P.A.



PANDA RESTAURANT GROUP INC.

1683 Walnut Grove Ave. Rosemead, California 1770 Telephone: 626.799.9898

Facsimile: 626.372.8288

All ideas, designs, arrangement and plans indicated or

represented by this drawing are the property of Panda Express Inc. and were created for use on this specific project. None of these ideas, designs, arrangements or plans may be used by or disclosed to any person, firm, or corporation without the written permission of Panda Express Inc.

REV	ISIONS:	
ISSL	JE DATE:	
1st	PLANNING	09.30.

DRAWN BY: NAB

PANDA PROJECT #: S8-17-D4987 ARCH PROJECT #: 16044.007

ENGINEER LICENSE #

ARCHITECT:

10955 LOWELL AVENUE, SUITE 700 OVERLAND PARK, KS 66210 ph: 913.649.8181 • fx: 913.649.1275


FOXWOOD AND DEAN PANDA EXPRESS

> Foxwood and Dean 1927 W. Foxwood Drive Raymore, MO 64083

LANDSCAPE PLAN

2- First step 1, then step 2. Adjust hole depth to allow for the removal of excess soil and roots over the root collar. 3- Roots and soil may be removed during the correction process; substrate/soil shall be replaced after the correction

4- Trees shall pass root observations detail following correction.

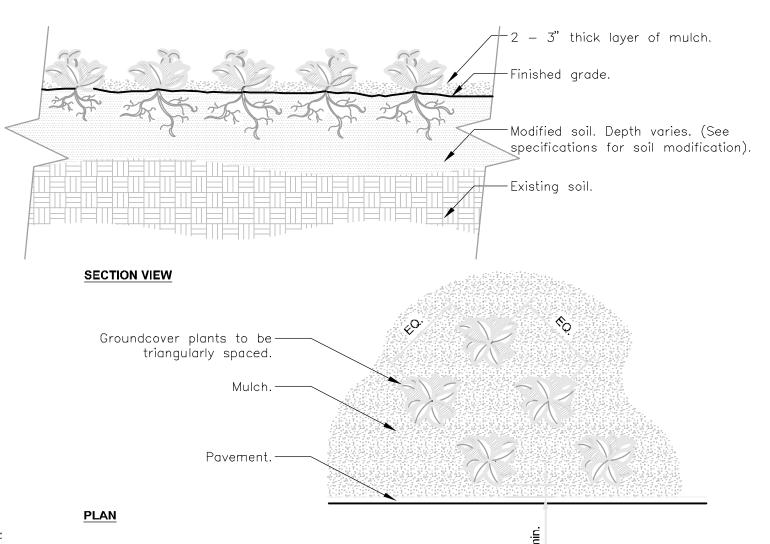


1— See planting legend for groundcover species, size, and spacing dimension. 2— Small roots (¼" or less) that grow around, up, or down the root ball periphery are considered a

normal condition in container production and are acceptable however they should be eliminated at the time of planting. Roots on the periperhy can be removed at the time of planting. (See root ball shaving container detail). 3- Settle soil around root ball of each groundcover prior to mulching.

GROUNDCOVER NOT TO SCALE

URBAN TREE FOUNDATION © 2014

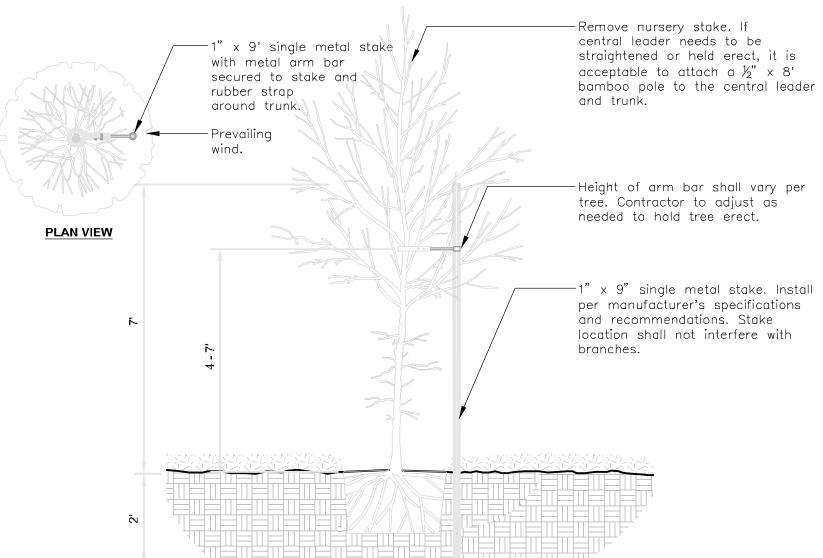


SECTION VIEW

TREE STAKING - SINGLE METAL STAKE

NOT TO SCALE

URBAN TREE FOUNDATION © 2014

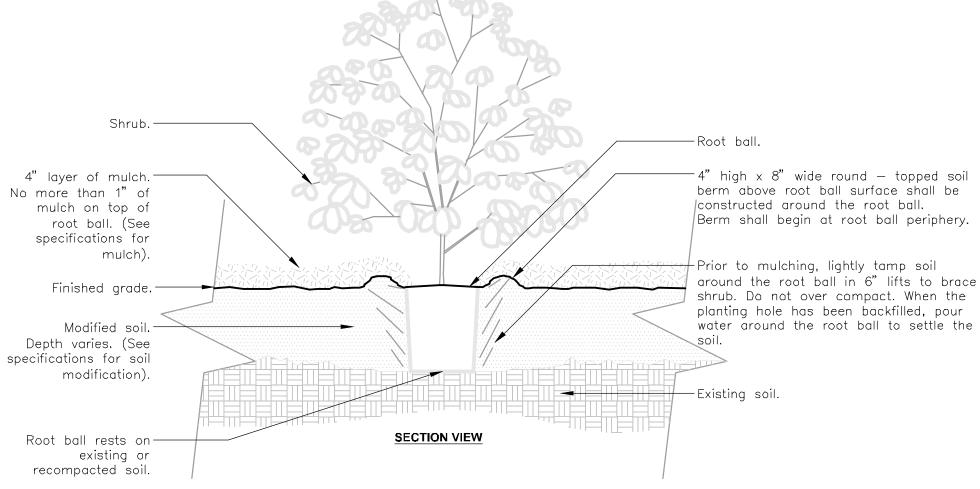

1- Shrubs shall be of quality prescribed in the root observations detail and specifications.

2- See specifications for further requirements related to this detail.

BE NO MORE THAN

SHRUB - MODIFIED SOIL

SELECT DESIRED SIZE

REFERENCE NUMBER 200-005

NOT TO SCALE

SURE-LOC CRISPEDGE

SURE-LOC SUREEDGE

SURE-LOC CRISPEDGE 1/8" X 4" X 16' SURE-LOC CRISPEDGE 1/8" X 5 1/2"

SURE-LOC SUREEDGE 3/16" X 5 1 2"

1/8" X 4"

1/8" X 5 1/2" 3/16" X 4"

DO NOT SCALE DRAWINGS.
 CONTRACTORS NOTE: FOR PRODUCT AND PURCHASING INFORMATION VISIT www.CADcelails.com/info

URBAN TREE FOUNDATION @ 2014

10-15% of soil depth. Install lifts in 6 - 8' rows. *TOP OF STACK DESIGNED TO LOCK 1/2" (12.7 mm) BELOW ADJACENT TO EDGING TO AVOID 15 PIECES (120 LINEAR FEET) PER BOX 15 PIECES (240 LINEAR FEET) PER BOX 15 PIECES (240 LINEAR FEET) PER BOX 10 PIECES (160 LINEAR FEET) PER BOX 10 PIECES (160 LINEAR FEET) PER BOX **SECTION VIEW** 1— Means and methods of soil compaction shall be determined at time of soil mock up. SURE-LOC ALUMINUM EDGING CORPORATION NOTES:

1. INSTALLATION TO BE COMPLETED IN ACCORDANCE WITH MANUFACTURER'S SPECIFICATIONS. 494 EAST 64TH ST

2— Soil compaction after installation shall be 75 — 250 PSI at soil moisture between field capacity and wilting point.

3— For soil depths see planting soil specifications.

4— See planting soil specification for additional requirements.

MODIFIED EXISTING SOIL - INSTALLED PLANTING MIX

PLANTING NOTES

1. LOCATION OF ALL EXISTING UTILITIES NEEDS TO DONE BEFORE COMMENCING

2. THE PLANTING PLAN GRAPHICALLY ILLUSTRATES OVERALL PLANT MASSINGS. EACH PLANT SPECIES MASSING SHALL BE PLACED IN THE FIELD TO UTILIZE THE GREATEST COVERAGE OF GROUND PLANE. THE FOLLOWING APPLIES FOR INDIVIDUAL PLANTINGS:

A. CREEPING GROUNDCOVER SHALL BE A MINIMUM OF 6" FROM PAVING EDGE. B. ALL TREES SHALL BE A MINIMUM OF 3' FROM PAVING EDGE.

C. ALL PLANTS OF THE SAME SPECIES SHALL BE EQUALLY SPACED APART AND PLACED FOR BEST AESTHETIC VIEWING.

D. ALL SHRUBS SHALL BE A MINIMUM OF 2' FROM PAVED EDGE. 3. MULCH ALL PLANTING BED AREAS TO A MINIMUM DEPTH OF 3". MULCH INDIVIDUAL

TREES TO A MINIMUM DEPTH OF 4". 4. NOTE: IF PLANTS ARE NOT LABELED - THEY ARE EXISTING AND SHALL REMAIN. 5. ALL LANDSCAPED AREAS IN ROW SHALL BE SODDED AND IRRIGATED UNLESS

MATERIALS:

OTHERWISE SPECIFIED.

1. PLANT MATERIAL SHALL BE HEALTHY, VIGOROUS, AND FREE OF DISEASE AND

INSECTS AS PER AAN STANDARDS. 2. SHREDDED BARK MULCH INSTALLED AT TREES SHALL BE FINELY CHIPPED AND SHREDDED HARDWOOD CHIPS, CONSISTING OF PURE WOOD PRODUCTS AND FRE OF ALL OTHER FOREIGN SUBSTANCES. PINE BARK COMPOST MULCH INSTALLED AT

PLANTING BED AREAS SHALL BE FREE OF ALL OTHER FOREIGN SUBSTANCES.

INSTALLATION:

1. ALL COMPACTED SOIL AND ROLL SPLIT WITHIN THE AREA TO BE LANDSCAPED SHALL BE REMOVED TO A DEPTH OF NOT LESS THAN TWO (2) FEET AND SHALL BE BACKFILLED WITH TOPSOIL.

2. ALL PLANTING BEDS SHALL BE AMENDED WITH 1 CUBIC YARD OF PEAT MOSS PER 1,000 SQUARE FEET. TILL PEAT MOSS INTO SOIL TO A 6" DEPTH. A 10-10-10 FERTILIZER SHALL BE SPREAD OVER ALL PLANTING AREAS PRIOR TO PLANTING, AT A RATE OF 50 POUNDS PER 2,000 SQUARE FEET.

3. AFTER PLANTS HAVE BEEN INSTALLED, ALL PLANTING BEDS SHALL BE TREATED

WITH DACTHAL PRE-EMERGENT HERBICIDE PRIOR TO MULCH APPLICATION.

4. PLANT PIT BACKFILL FOR TREES AND SHRUBS SHALL BE 50% PEAT OR WELL

COMPOSTED MANURE AND 50% TOPSOIL. 5. TREES PLANTED IN LANDSCAPED PLANTING AREAS SHALL BE SITUATED A MINIMUM OF THREE (3) FEET FROM ANY CURB.

6. PLANT MATERIAL SHALL BE MAINTAINED AND GUARANTEED FOR A PERIOD OF ONE YEARS AFTER OWNER'S ACCEPTANCE OF FINISHED JOB. ALL DEAD OR DAMAGED PLANT MATERIAL SHALL BE REPLACED AT LANDSCAPE CONTRACTOR'S EXPENSE.

7. LANDSCAPE CONTRACTOR SHALL MAINTAIN ALL PLANT MATERIAL UNTIL FINAL ACCEPTANCE, AT WHICH POINT THE ONE YEAR GUARANTEE BEGINS.

PANDA RESTAURANT GROUP INC.

1683 Walnut Grove Ave. Rosemead, California 1770 Telephone: 626.799.9898 Facsimile: 626.372.8288

All ideas, designs, arrangement and plans indicated or represented by this drawing are the property of Panda Express Inc. and were created for use on this specific project. None of

these ideas, designs, arrangements or plans may be used by or disclosed to any person, firm, or corporation without the written

permission of Panda Express Inc.

REVISIONS: ISSUE DATE: 1st PERMIT

DRAWN BY: NAB

PANDA PROJECT #: S8-17-D4987 ARCH PROJECT #: 16044.007



LICENSE #

ARCHITECT:

10955 LOWELL AVENUE, SUITE 700

OVERLAND PARK, KS 66210 ph: 913.649.8181 • fx: 913.649.1275

FOXWOOD AND DEAN PANDA EXPRESS

> Foxwood and Dean 1927 W. Foxwood Drive Raymore, MO 64083

LANDSCAPE DETAILS

ALUMINUM LANDSCAPE EDGING

DETAIL-FILE

HOLLAND, MI 49423

TOLL FREE: 1-800-787-3562

PHONE. (616) 392-3209

FAX: (616) 392-5134

www.surelocedging.com

P-CO-PAN-GENP-14

7101 College Blvd., Suite 400 Overland Park, Kansas 66210 p. (913) 663-1900 f. (913) 663-1633 BHC RHODES is a trademark of Brungardt Honomichl & Company, P.A.

Loosen subgrade by dragging teeth of

-Proposed finished

-Finish grade after installation but before settlement.

-Pavement.


Existing soil. Confirm subgrade drains one $\frac{1}{2}$ half inch

per hour or

greater.

grade after settlement.

bucket.

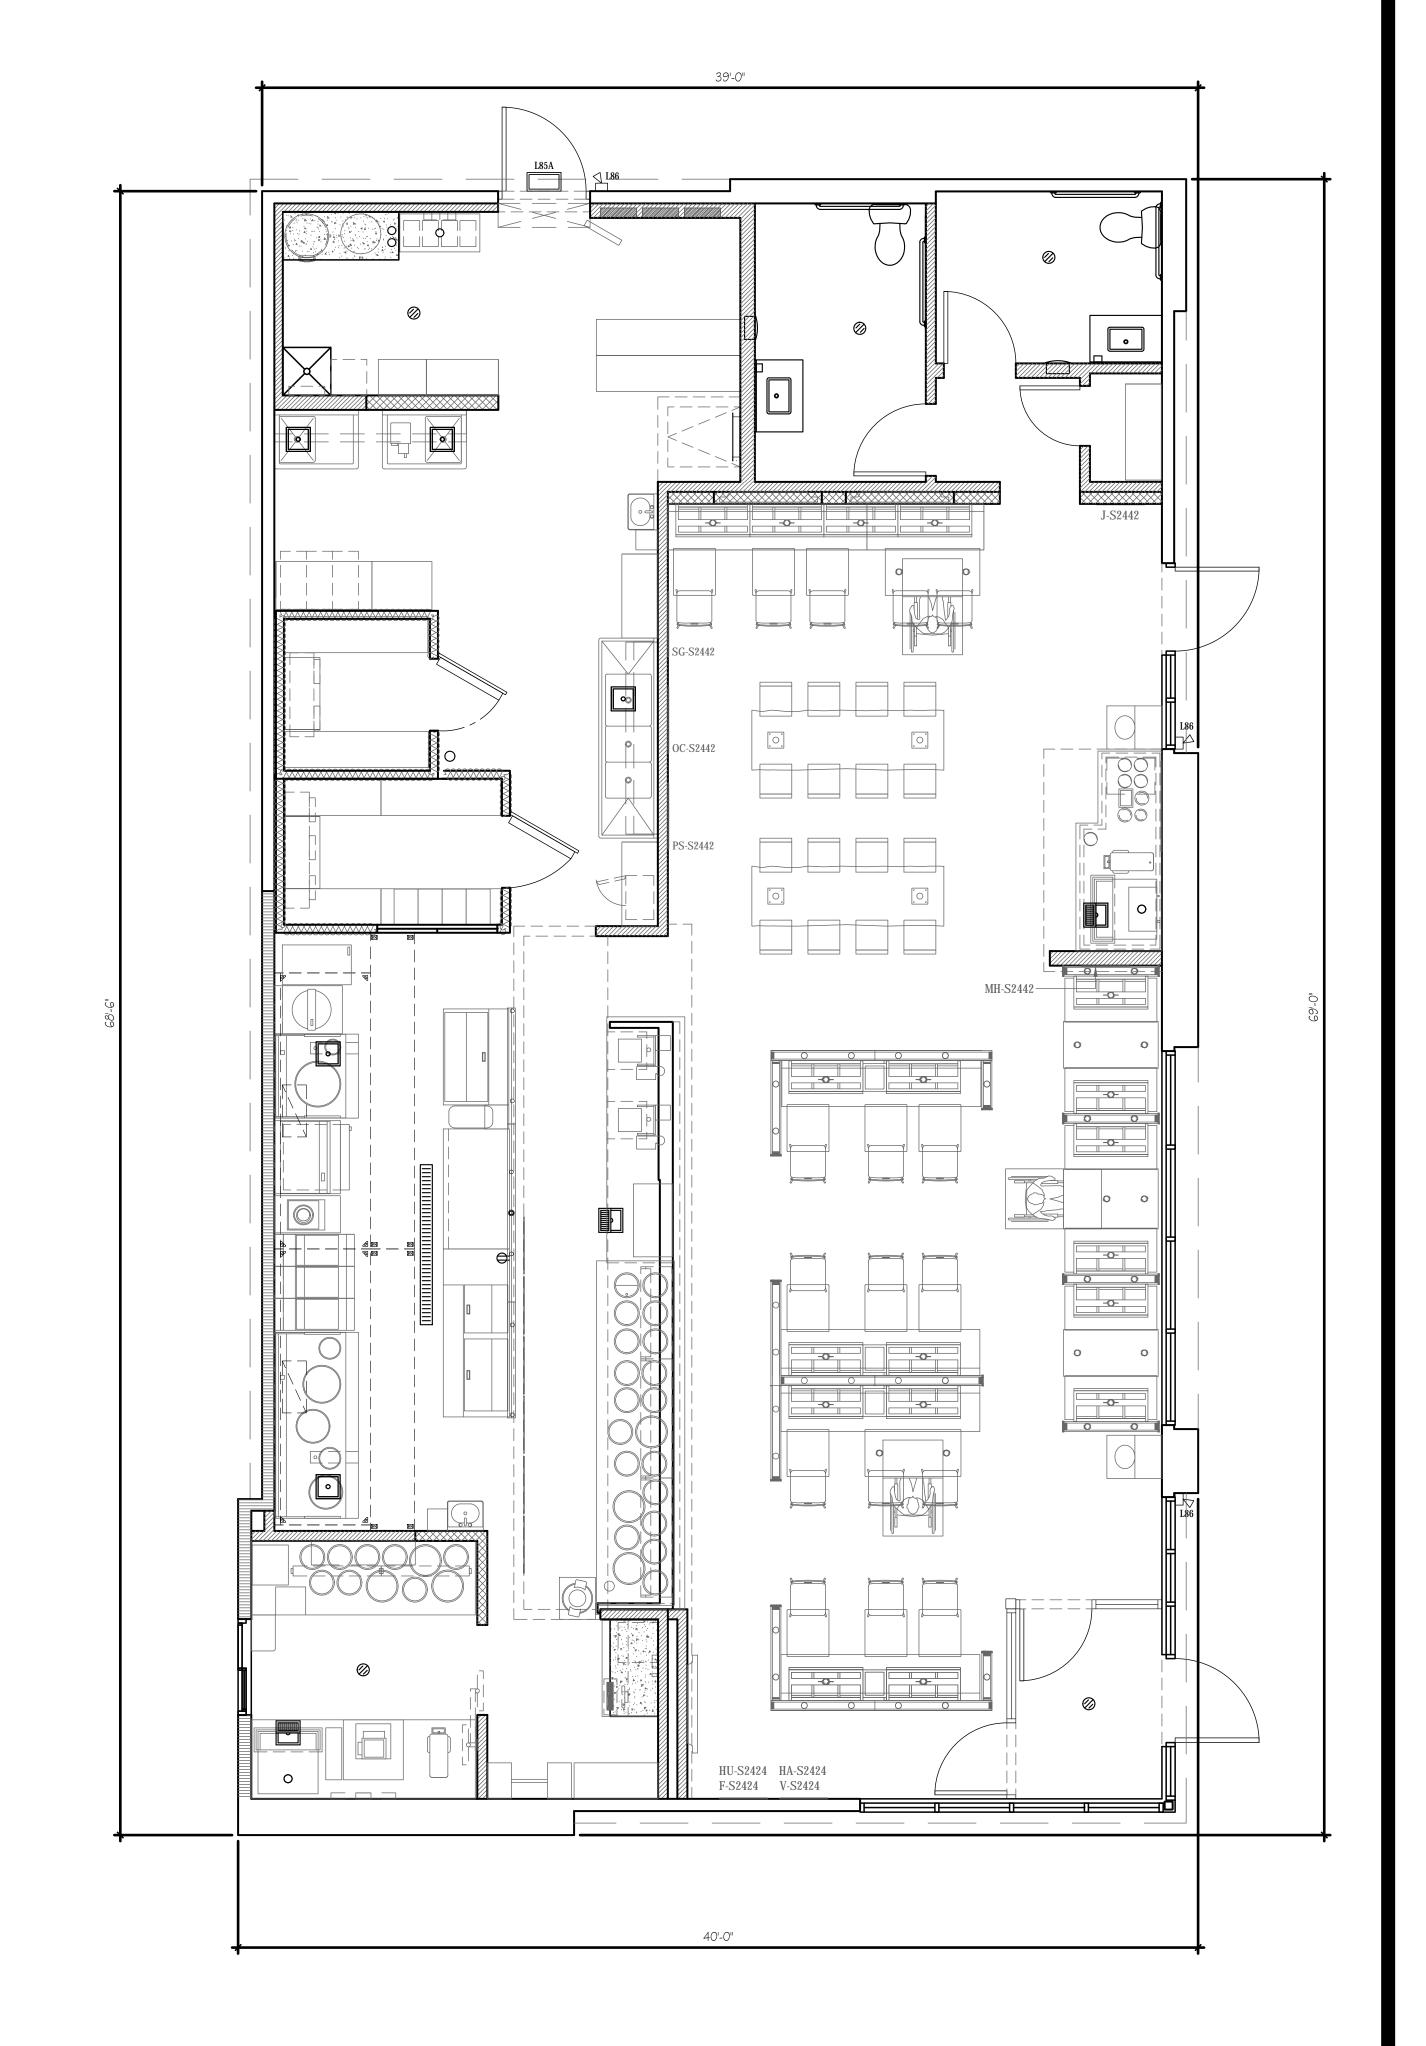





1683 Walnut Grove Ave. Rosemead, California 91770

Telephone: 626.799.9898 Facsimile: 626.372.8288

All ideas, designs, arrangement and plans indicated or represented by this drawing are the property of Panda Express Inc. and were created for use on this specific project. None of these ideas, designs, arrangements or plans may be used by or disclosed to any person, firm, or corporation without the written permission of Panda Express Inc.

ISSUE DATE: 1st PLANNING 09.30.10
1st PLANNING 09.30.10

DRAWN BY: VTL

PANDA PROJECT #: S8-17-D4987

ARCH PROJECT #: 16044.007

ARCHITECT:



10955 LOWELL AVENUE, SUITE 700 OVERLAND PARK, KS 66210 ph: 913.649.8181 • fx: 913.649.1275


FOXWOOD AND DEAN PANDA EXPRESS

Foxwood and Dean 1927 W. Foxwood Drive Raymore, MO 64083

A-100


FLOOR PLAN


PLANNING SUBMITTAL 09.30.16

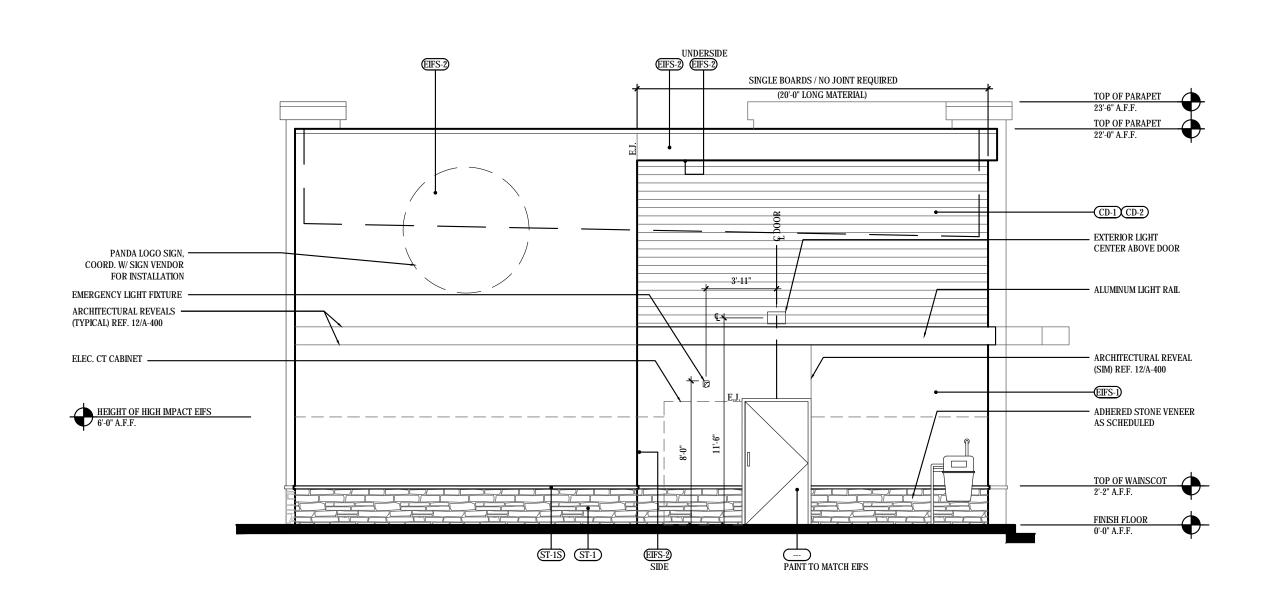


SOUTH ELEVATION SCALE: 1/4" = 1'-0"

EXT	ERIOR FIN	NISH SCHI	EDULE INSTALLED AN	ND FURNISHED BY. G.C. UNLESS NOTED OTHERWISE	03-14-16
NO	MANUFACTURER	MFG#	COLOR	FINISH	NOTES
(EIFS-1)		STOTHERM ESSENCE SYSTEM	SW 6148 WOOL SKEIN	FINE	BUILDING BODY
ŒFS-2		STOTHERM ESSENCE SYSTEM	SW 7548 PORTICO	FINE	BUILDING BODY / PARAPET
ŒFS-3		STOTHERM ESSENCE SYSTEM	SW 2849 WESTCHESTER GRAY	FINE	BUILDING TOWER
EIFS-4	STO STO	STOTHERM ESSENCE SYSTEM	SW 7069 IRON ORE	FINE	TOWER CORNICE
CD-1	FIBERON	HORIZON	IPE	60% MATERIAL COVERAGE - RANDOM MIX (NON-GROOVE)	COMPOSITE DECKING - CONTACT: BILL ROSS 704-756-1980 EMAIL: Billr@fiberondecking.com
CD-2	FIBERON	HORIZON	TUDOR BROWN	40% MATERIAL COVERAGE - RANDOM MIX (NON-GROOVE)	COMPOSITE DECKING - CONTACT: BILL ROSS 704-756-1980 EMAIL: Billr@fiberondecking.com
(P114)	SHERWIN-WILLIAMS	SW 7069	IRON ORE	A100 SATIN, LATEX	ALUM. AWNINGS/CANOPY (PRE-FINISHED)
ST-1S	CREATIVE MINES	-	BLACK TEA	FLAMED	STONE CAP - CONTACT: ALLISON DILLARD 949-355-3840
ST-1	CREATIVE MINES	-	NIRVANA 120/121	CRAFT SPLIT MODULAR	WAINSCOT - DRY STACK / TIGHT JOINT - CONTACT: ALLISON DILLARD 949-355-3840

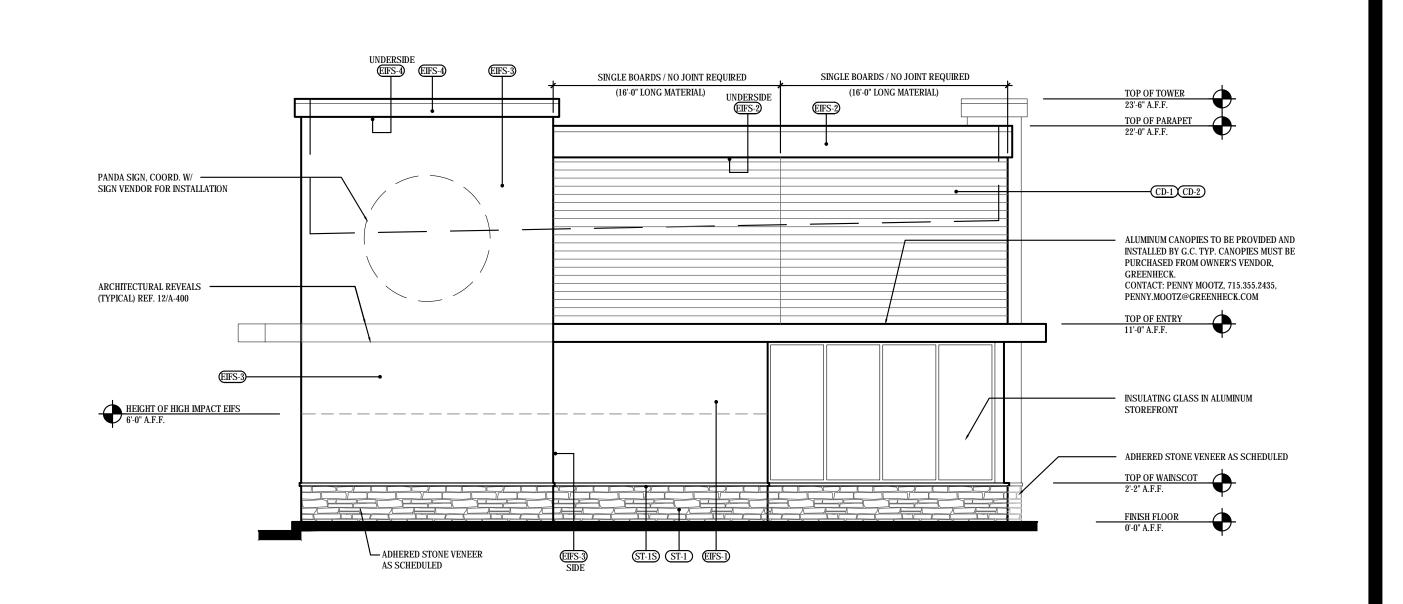

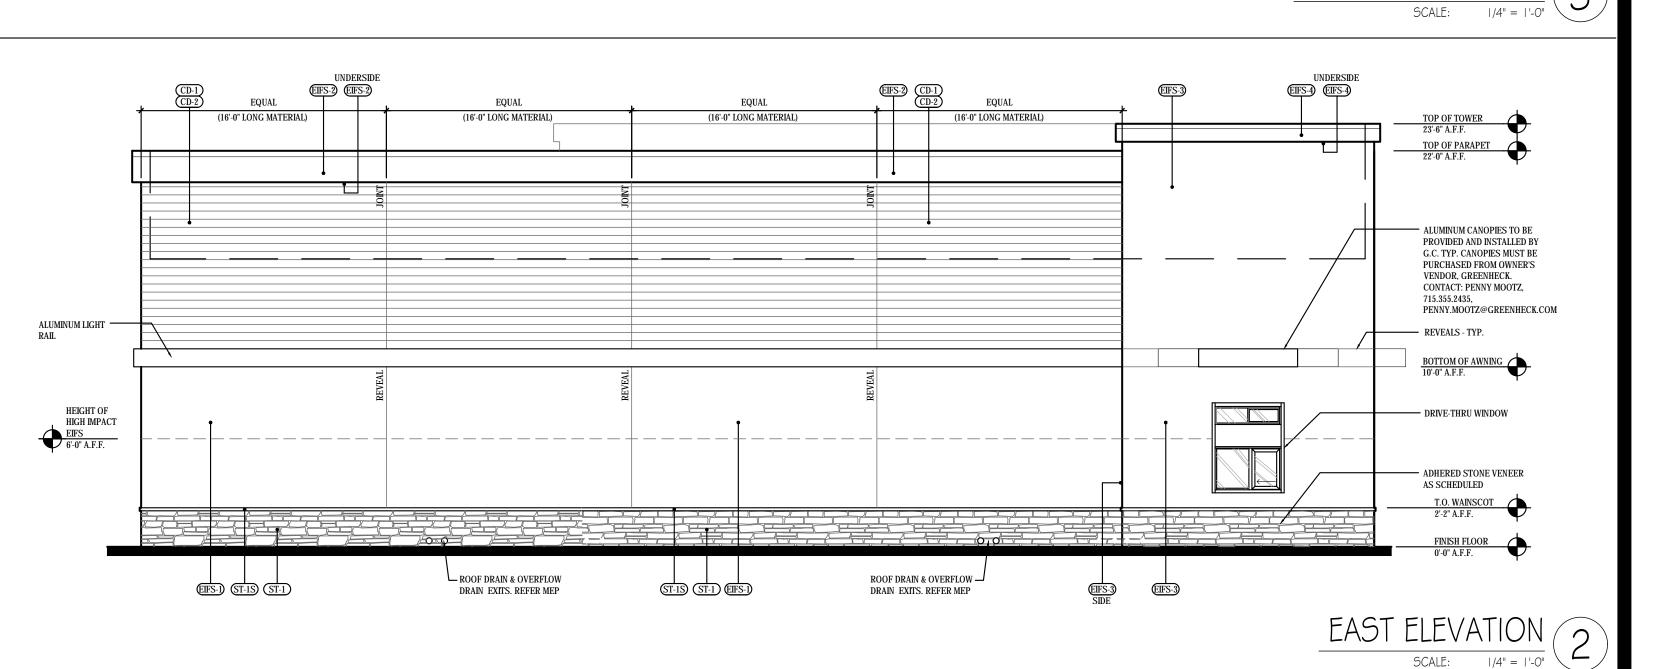

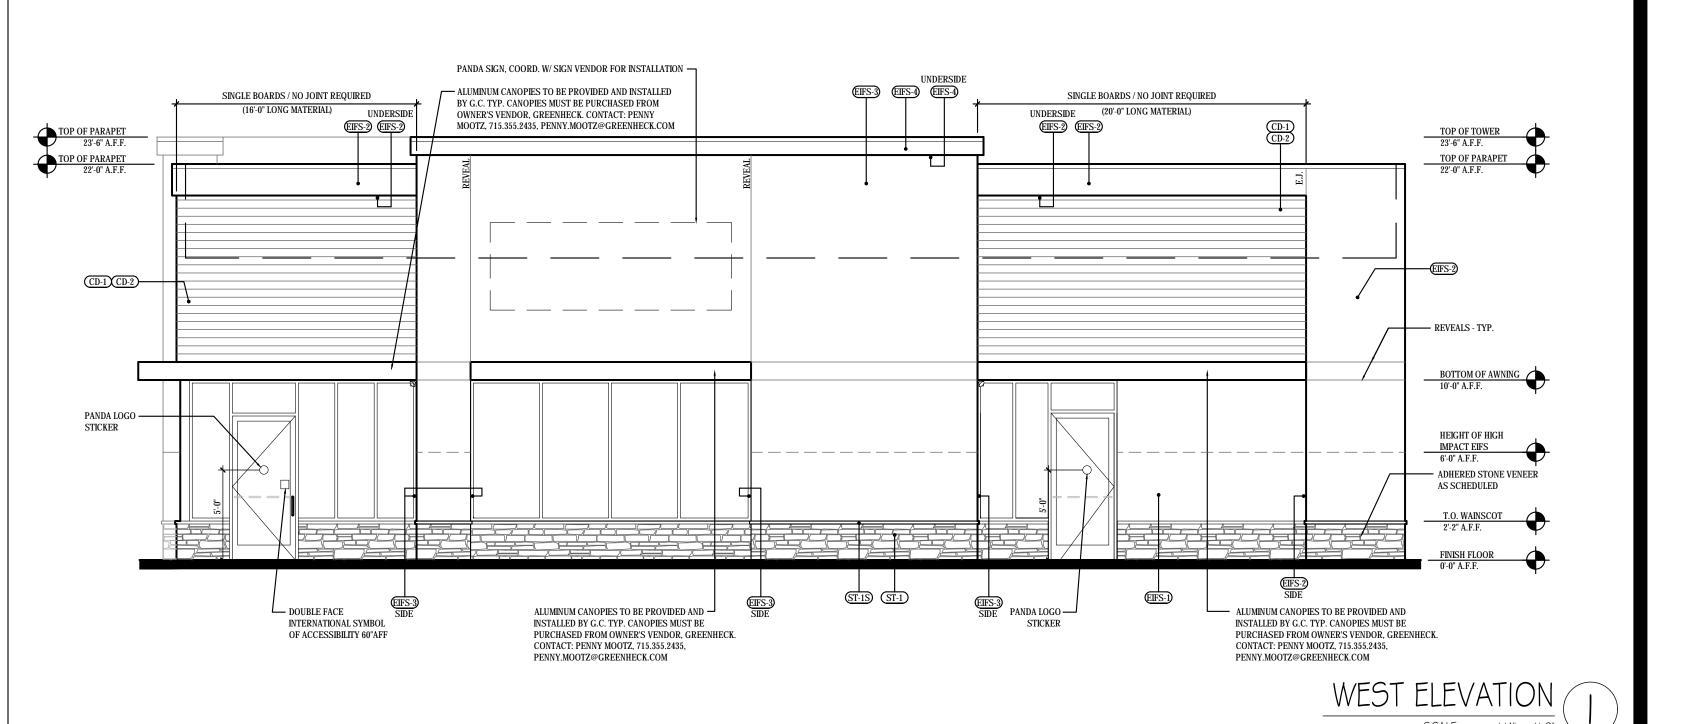



PANDA RESTAURANT GROUP INC. 1683 Walnut Grove Ave. Rosemead, California 91770

Telephone: 626.799.9898 Facsimile: 626.372.8288

All ideas, designs, arrangement and plans indicated or represented by this drawing are the property of Panda Express Inc. and were created for use on this specific project. None of these ideas, designs, arrangements or plans may be used by or disclosed to any person, firm, or corporation without the written permission of Panda Express Inc.

	VISIONS:	
221	UE DATE:	
1st	PLANNING	09.30.

PANDA PROJECT #: S8-17-D4987 ARCH PROJECT #: 16044.007

ARCHITECT:

kloverarchitec

10955 LOWELL AVENUE, SUITE 700 OVERLAND PARK, KS 66210 ph: 913.649.8181 • fx: 913.649.1275

FOXWOOD AND DEAN PANDA EXPRESS

Foxwood and Dean 1927 W. Foxwood Drive Raymore, MO 64083

\-200

EXTERIOR ELEVATIONS

PLANNING SUBMITTAL 09.30.16





SOUTH ELEVATION 12

NORTH ELEVATION 3



EAST ELEVATION 2



WEST ELEVATION (

PANDA RESTAURANT GROUP INC.

PANDA RESTAURANT GROUP II 1683 Walnut Grove Ave. Rosemead, California 91770

Telephone: 626.799.9898 Facsimile: 626.372.8288

All ideas, designs, arrangement and plans indicated or represented by this drawing are the property of Panda Express Inc. and were created for use on this specific project. None of these ideas, designs, arrangements or plans may be used by or disclosed to any person, firm, or corporation without the written permission of Panda Express Inc.

REV	ISIONS:	
ISSU	JE DATE:	
1st	PLANNING	09.30.1
DRA	WN BY: VTL	
PAN	DA PROJECT #:	S8-17-D4987
ARC	H PROJECT #:	16044.007

ARCHITECT:

kloverarchitec

10955 LOWELL AVENUE, SUITE 700 OVERLAND PARK, KS 66210 ph: 913.649.8181 • fx: 913.649.1275


FOXWOOD AND DEAN PANDA EXPRESS

Foxwood and Dean 1927 W. Foxwood Drive Raymore, MO 64083

A-201

COLOR ELEVATIONS

PLANNING SUBMITTAL 09.30.16

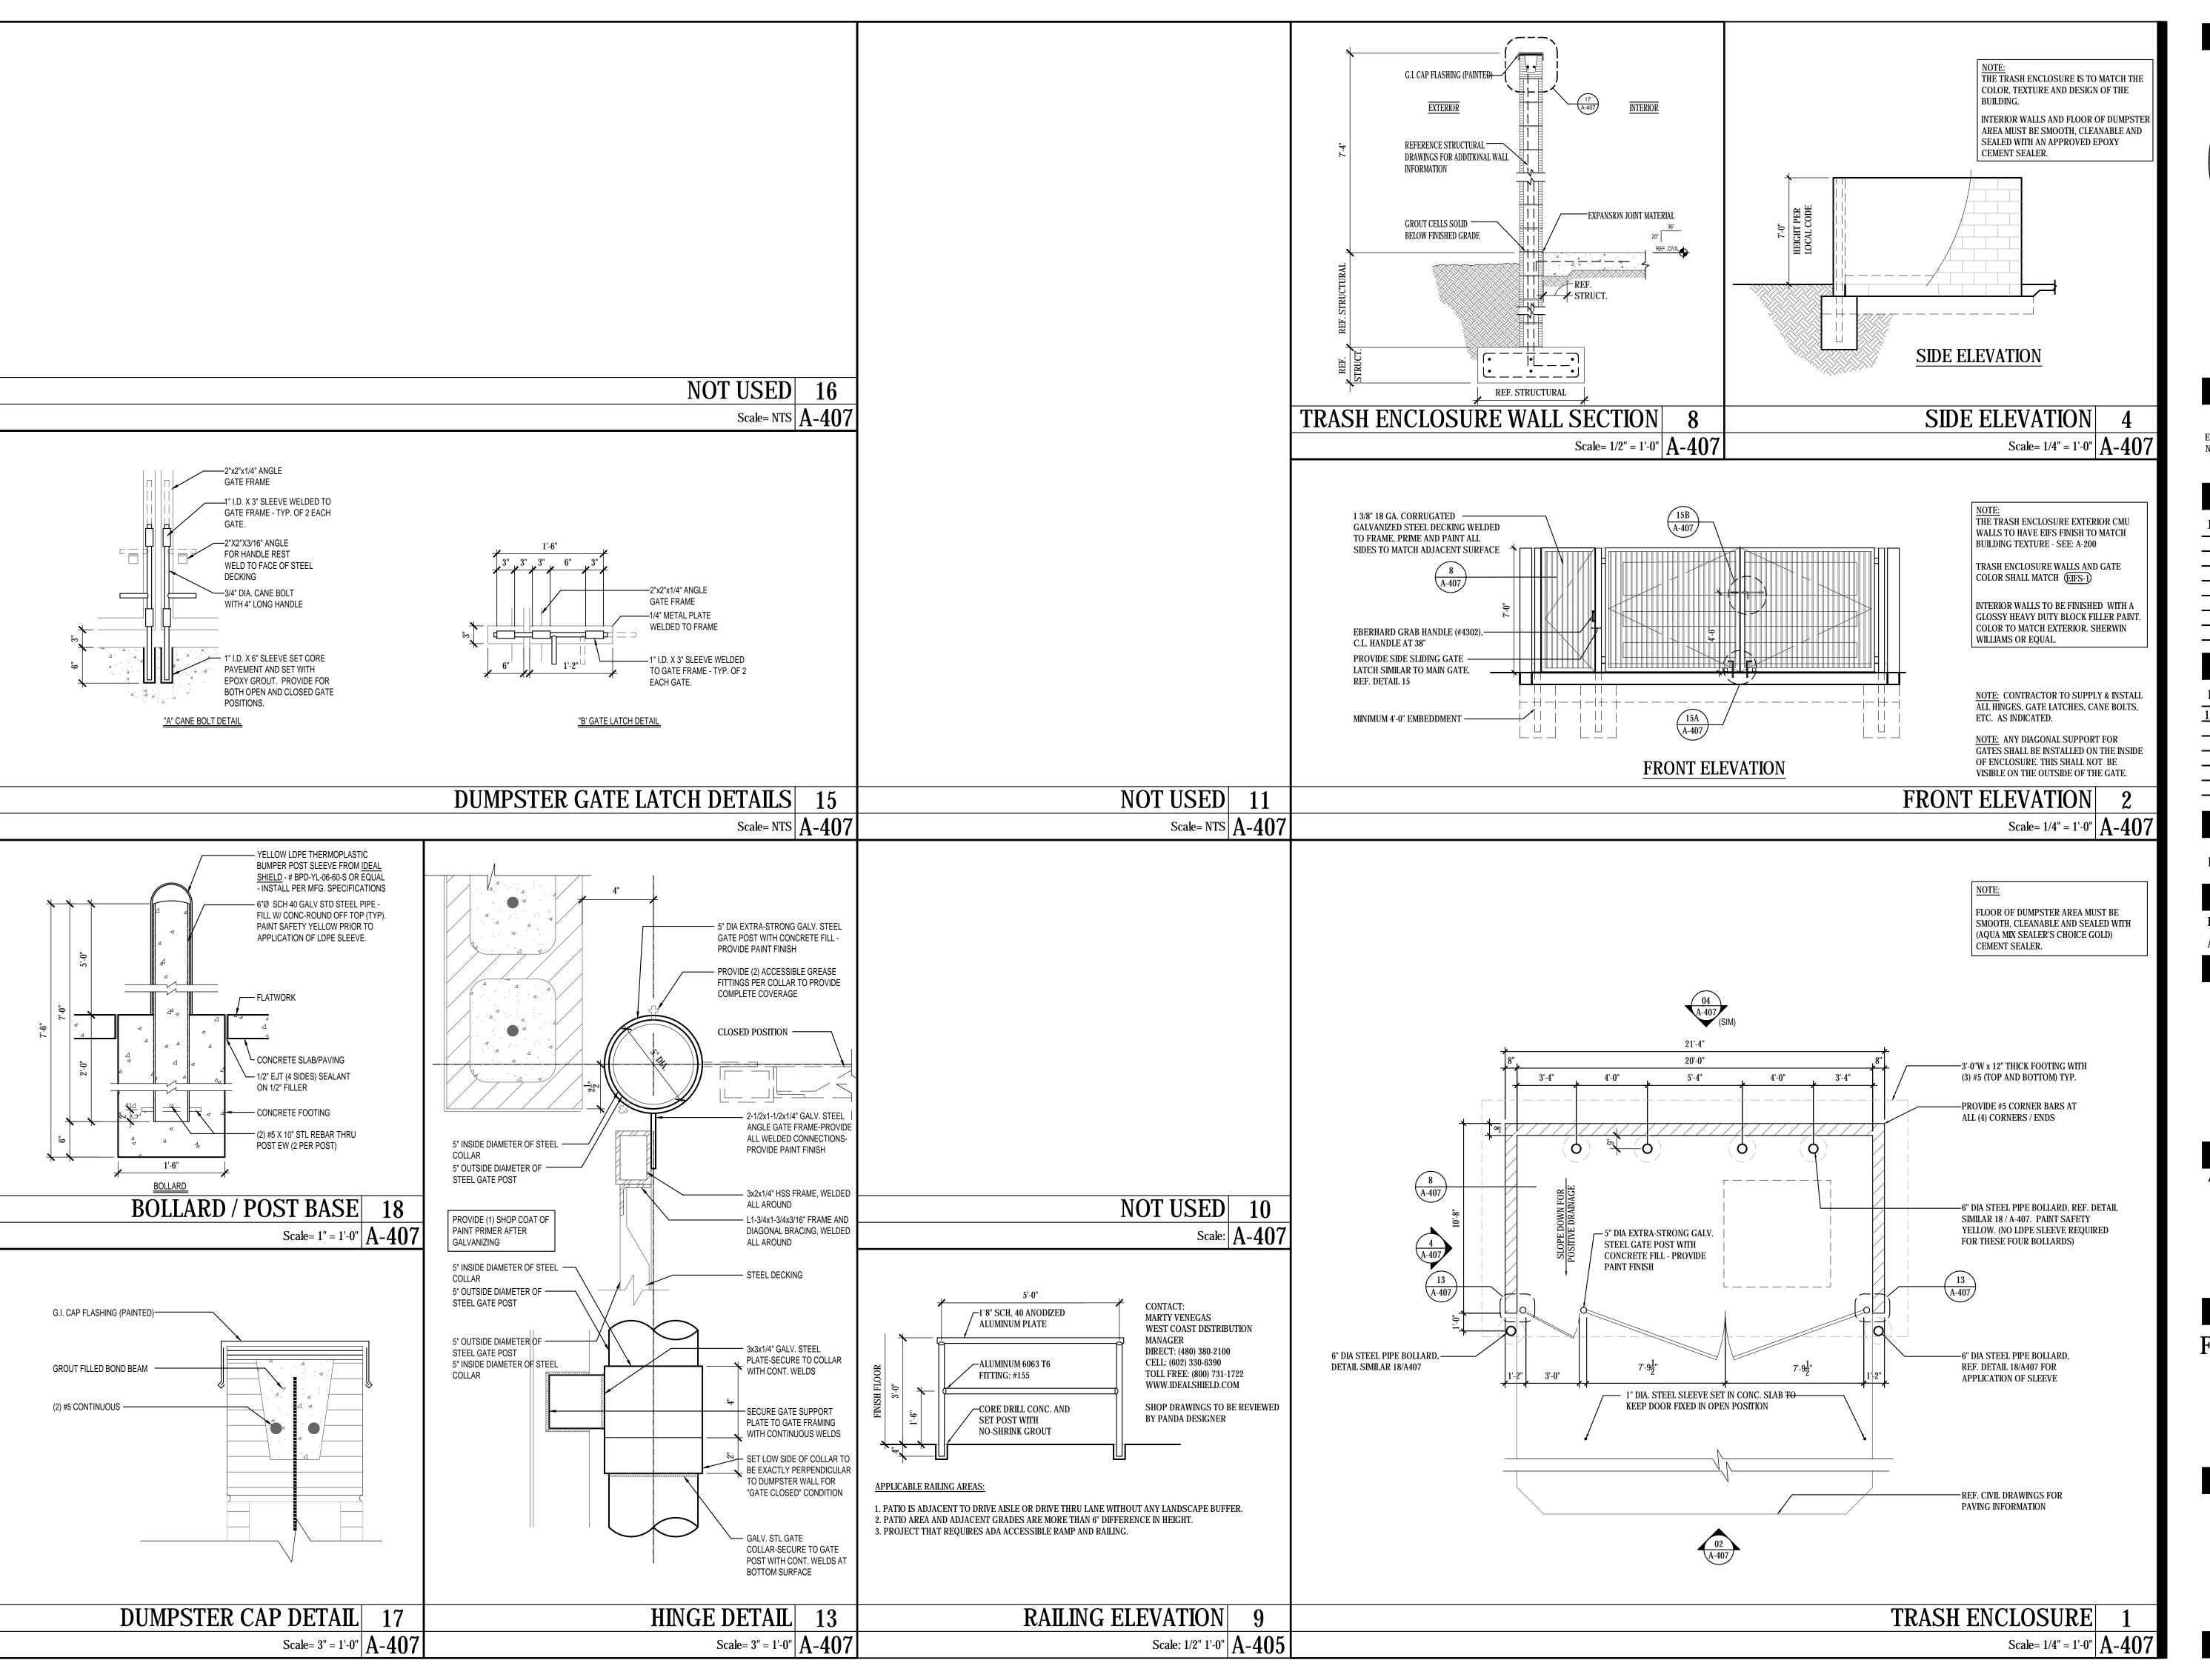



PANDA RESTAURANT GROUP INC 1683 Walnut Grove Ave. Rosemead, California 91770

> Telephone: 626.799.9898 Facsimile: 626.372.8288

All ideas, designs, arrangement and plans indicated or represented by this drawing are the property of Panda Express Inc. and were created for use on this specific project. None of these ideas, designs, arrangements or plans may be used by or disclosed to any person, firm, or corporation without the written permission of Panda Express Inc.

ISS	UE DATE:	
	PLANNING	

DRAWN BY: VTL

PANDA PROJECT #: S8-17-D4987
ARCH PROJECT #: 16044.007

ARCHITECT:

kloverarchited

10955 LOWELL AVENUE, SUITE 700 OVERLAND PARK, KS 66210 ph: 913.649.8181 • fx: 913.649.1275

FOXWOOD AND DEAN PANDA EXPRESS

Foxwood and Dean 1927 W. Foxwood Drive Raymore, MO 64083

-407

TRASH ENCLOSURE

NOTES:

MOUNTING HEIGHT OF 22'-0" POLE HEIGHT: 20'-0"

POLE BASE: 2'-0"
CALCULATIONS TAKEN AT GROUND LEVEL.
CONTACT VILLA LIGHITNG - JEFF CLAUSS: 314-531-2600

CALC. SUI	MMA	RY -	PAV	ED S	URF/	4CE
CALC TYPE	UNITS	AVG	MAX	MIN	AVG / MIN	MAX / MIN
	_		40.4	4.0		40.4.4

NOTE: AFTER HOURS DIMMED ILLUMINANCE LEVELS ARE APPROX. 1/2 OF THE ABOVE VALUES.

CALC. SUMMARY - PROPERTY LINE AVG AVG/MIN MAX/MIN ILLUMINANCE

NOTE: AFTER HOURS DIMMED ILLUMINANCE LEVELS ARE APPROX. 1/2 OF THE ABOVE VALUES.

PANDA SITE LIGHTING DESIGN CRITERIA 2 NO SCALE E-106

ALL SITE LIGHTING ARE PROVIDED AND INSTALLED BY GC. GC. TO PURCHASE FIXTURE THRU PANDA APPROVED LIGHTING VENDOR.

	LIGHTING FIXT	UR	ES	CHEDULE
FIXTURE TAG	MANUFACTURER and CATALOG NUMBER	VOLTS VA	LAMP INFO.	FIXTURE DESCRIPTION and REMARKS
'S1'	LSI INDUSTRIES VILLA LIGHTING-XGBM-FT-LED-HO-NW-HSS	288.8	LED	17359.83 Lumens Per Lamp

0.0 0.1 0.1 0.1 0.1 0.1 0.2 0.3 0.3 0.4 0.5 0.5 0.6 0.6 0.7 0.7 0.7 0.8 0.8 0.8 0.8 0.8 0.8 0.7 0.6 0.5 0.4 0.4 0.2 1.2 1.4 2.0 2,7 2.7 2 7 2.8 2.8 2.3 2.0 1.9 1.9 1.9 1.8 1.9 2.0 2.1 1.7 1.4 1.6 3.1 4.8 6.6 9 0 10.11 0.310.09.1 6.7 5.1 3.6 2.9 2.6 2.6 2.7 2.9 2.9 2.5 1.9 2.4 [†]2.4 [†]3.7 [†]5.2 [†]6.8 [†]7.4 [†]8.0 [†]7.7 [†]7.5 [†]6.0 [†]4.7 [†]3.8 [†]3.5 [†]3.2 [†]3.0 [†]3.2 [†]3.7 [†]4.0 [†]3.5 [†]2.9 [†]3.6 [†]2.4 †1.3 †2.0 †2.6 †3.6 †4.9 †5 9 †6.1 †6.3 †6.2 †6.2 †5.3 †4.3 †3.6 †3.5 †3.4 †3.5 †3.9 †4.7 †5.2 †4.5 †3.9 †5.2 †3.6 †1.7 †2.5 †3.3 †4.6 †6.0 †6.9 †7.0 †7.2 †7.1 †7.0 †6.2 †5.2 †4.3 †4.0 | 3.8 | 3.9 | 4.5 | 5.5 †6.3 †5.6 †5.1 †7.6 †5.0 1.9 2.7 3.5 4.6 5.8 6.6 6.8 6.9 6.9 7.0 6.3 5.4 4.6 4.3 41 40 4.6 5.9 6.6 6.0 5.8 8.7 5.3 1.2 2.0 2.6 3.3 4.1 4.9 5.3 5.4 5.5 5.6 5.7 5.4 4.9 4.5 3.9 3.9 4.1 4.7 6.1 7.0 6.3 6.2 9.6 4 5.1 1.2 ².1 ².8 ³.2 ³.8 ⁴.3 ⁴.5 ⁴.4 ⁴/₄3 ⁴.3 ⁴.3 ³.9 ³.4 1.5 2.3 3,3 3.4 3.9 4.3 4.3 4.1 3 9 3.9 3.8 3.5 3.1 1.6 \(^2.8\) \(^4.0\) \(^3.6\) \(^4.2\) \(^4.6\) \(^4.5\) \(^4.1\) \(^3.8\) \(^3.7\) \(^3.5\) \(^3.2\) \(^2.9\) 1.8 4.0 5.0 4.3 4.9 5.1 4.7 4.1 3.7 3.5 3.2 2.9 2.7 2.2 5.8 6.3 5.0 5.7 6.0 5.2 4.3 3.7 3.4 3.0 2.7 2.4 [†]4.1 [†]1.7 2.6 8.3 7.9 6.0 6.7 6.7 5.5 4.4 3.7 3.3 2.8 2.5 2.2 [†]2.8 [†]1.4 1.7 \(^1\)2.7 \(^1\)9.6 \(^1\)8.2 \(^1\)6.3 \(^1\)7.0 \(^1\)6.8 \(^1\)5.4 \(^1\)4.2 \(^1\)3.6 \(^1\)3.1 \(^1\)2.6 \(^1\)2.3 \(^1\)2.1 [†]2.1 [†]1.3 2.7 [†]10.18.2 [†]6.4 [†]7.1 [†]6.7 [†]5.1 [†]4.0 [†]3.3 [†]2.9 [†]2.4 [†]2.1 [†]1.9 [†]1.7 [†]1.2 2.8 10.27.4 6.1 7.0 6.5 4.9 3.8 3.2 2.7 2.3 1.9 1.8 [†]1.8 [†]1.2 [†]2.2 [†]1.**5** 3.1 9.2 6.6 5.9 6.9 6.2 4.8 3.8 3.1 2.7 2.3 1.9 1.7 2.6 7.0 5.3 5.3 6.3 5.9 4.6 3.7 3.2 2.7 2.3 2.0 1.7 2.1 5.0 3.9 4.2 5.2 5.0 4.1 3.5 3.0 2.6 2.2 1.9 1.6 [†]3.5 [†]3.0 1.8 3.5 2.9 3.3 4.1 4.1 3.7 3.3 3.1 2.9 2.2 1.9 1.7 4.9 4.6 1.5 2.6 2.4 2.9 3.4 3.6 3.4 3.1 3.0 2.8 2.7 2.6 2.7 1.3 2.2 2.5 2.6 3.1 3.4 3.3 3.1 3.0 2.9 2.8 2.7 2.8 2.9 3.2 3.6 3.7 4.4 5.6 6.8 6.7 6.0 8.0 8.0 1.3 2.2 2.9 2.6 3.3 3.6 3.4 3.2 3.0 3.0 2.8 2.8 2.8 2.8 2.9 3.0 3.7 4.4 5.4 6.7 6 6 6.0 8.6 8.4 s1 1.3 2.8 3.4 3.0 3.6 3.9 3.7 3.4 3.1 3.0 2.9 2.8 2.8 2.9 3.1 3.3 3.7 4.4 5.5 6.8 6.7 6.2 8.8 8.3 1.5 4.6 4.6 3.8 4.6 4.8 4.3 3.7 3.4 3.2 3.0 2.9 2.9 2.9 3.0 3.2 3.4 3.8 4.5 5.6 6.8 6.5 6.1 8.1 8.3 2.1 6.6 6.1 5.0 5.8 5.8 4.9 4.1 3.6 3.3 3.1 3.0 3.0 3.1 3.3 3.6 4.0 4.6 5.6 6.7 6.3 5.6 7.4 7.3 2.6 9.0 7.4 5.9 6.7 6.6 5.2 4.3 3.8 3.5 3.2 3.1 3.1 3.2 3.4 3.7 4.0 4.6 5.3 5.9 5.5 4.6 5.5 5. <u>- 2.6 10.17.5 6.0 6.9 6.6 5.2 4.2 3.7 3.4 3.2 3.1 3.2 3.3 3.5 3.8 4.1 4.5 5.0 5.1 4.7 4.1 4.2 3.6 </u> 2.7 10.47.4 6.1 7.0 6.5 5.0 4.1 3,6 3.4 3.2 3.2 3.3 3.4 3.7 3.9 4.2 4.6 4.9 4.7 4 2 3.9 3.4 2.5 3.2 9.9 6.7 6.0 6.9 6.4 5.0 4.0 3 6 3.4 3.2 3.2 3.3 3.6 3.8 4.1 4.5 5.0 5.2 4 4.1 4.5 3.2 2.0 3.6 8.7 6.1 5.9 6.9 6.3 4.9 4.1 3.7 3.4 3.3 3.3 3.4 3.7 4.0 4.3 4.9 5.6 6.0 5.2 4.7 5.7 3.1 4.9 3.0 6.2 4.8 5.1 6.1 5.7 4.7 4.0 3.7 3.5 3.4 3.4 3.6 3.9 4.2 4.6 5.3 6.5 7.0 6.1 5.8 7.5 3.7 2.5 4.6 3.7 4.2 5.0 4.8 4.2 3.8 3.6 3.5 3.5 3.5 3.5 4.0 4.8 5.6 7.1 7.7 6.8 6.9 9.6 4.4 $\begin{array}{c} 2.5 & 4.6 & 3.7 & 4.2 & 3.0 & 4.0 & 4.0 & 3.7 & 3.6 & 3 & 5 & 3.5 & 3.6 & 3.8 & 4.0 & 4.3 & 4.8 & 5 & 8 & 7.2 & 7.9 & 6.9 & 7.6 & 9.9 & 9$ 2.0 2.7 2.6 3.0 3.5 3.5 3.5 3.4 3 5 3.5 3.6 3.8 4.0 4 2 4.5 5.0 5.9 7.4 8.2 7.3 7.9 11.33 9 1.9 2.2 2.5 2 7 3.0 3.2 3.3 3.5 3 7 3.8 4.0 4.2 4.5 4 8 5.2 5.7 6 5 7.9 8.3 7.4 7.9 2.1 2.4 2.7 3.0 3.2 3.3 3.5 3.7 3.9 4.0 4.2 4.4 4.7 5.1 5.4 5.9 6.5 7.5 7.7 6.8 7.0 8.4 ².2 ².6 ³.0 ³.3 ³.5 ³.6 ³.7 ⁴.0 ⁴.2 ⁴.2 ⁴.3 ⁴.5 ⁴.8 ⁵.1 ⁵.5 ⁵.9 ⁶.3 ⁶.8 ⁶.9 ⁶.2 ⁶.2 ⁷.0 ³.4 ².4 ².9 ³.4 ³.8 ³.9 ⁴.0 ⁴.2 ⁴.5 ⁴.6 ⁴.5 ⁴.6 ⁴.5 ⁴.6 ⁴.9 ⁵.2 ⁵.7 ⁶.1 ⁶.3 ⁶.5 ⁶.4 ⁵.8 ⁵.7 ⁵.8 ³.4 ².7 ³.4 ⁴.1 ⁴.7 ⁴.9 ⁵.0 ⁵.2 ⁵.3 ⁵.3 ⁵.1 ⁴.9 ⁴.8 ⁵.1 ⁵.5 ⁶.1 ⁶.6 ⁶.8 ⁶.9 ⁶.8 ⁶.4 ⁶.2 ⁵.5 ³.7 ³.0 ⁴.0 ⁵.1 ⁶.1 ⁶.3 ⁶.5 ⁶.7 ⁶.8 ⁶.4 ⁵.7 ⁵.2 ⁵.0 ⁵.3 ⁵.8 ⁶.7 ⁷.6 ⁷.8 ⁷.9 ⁷.7 ⁷.2 ⁶.8 ⁵.6 ³.9 ².9 ⁴.1 ⁵.4 ⁶.5 ⁶.8 ⁷.1 ⁷.1 ⁷.2 ⁶.6 ⁵.6 ⁴.8 ⁴.7 ⁴.8 ⁵.4 ⁶.4 ⁷.4 ⁷.7 ⁷.8 ⁷.5 ⁷.1 ⁶.4 6.0 ³.5 2.3 \$3.3 \$4.5 \$5.6 \$5.8 \$6.1 \$6.1 \$6.1 \$5.5 \$4.5 \$3.8 \$3.7 \$3.8 \$4.3 \$5.1 \$6.1 \$6.5 \$6.7 \$6.5 \$6.1 \$5.3 \$4.0 \$2.8 2.2 \$.4 \$.4 \$.7 \$6.2 \$6.6 \$7.1 \$6.9 \$6.7 \$5.6 \$4.4 \$3.6 \$3.6 \$3.6 \$4.1 \$5.0 \$6.7 \$7.7 \$8.4 \$8.5 \$7.8 \$6.9 \$5.0 \$3.3 <u>5.8 4.4 6.1 8.8 9.9 10.410.49.4 7.3 5.6 4.1 3.5 3.6 4.6 6.0 8.5 9.8 10.49.8 9.1 7.4 5.0 3.1 </u> 1.1 1.3 1.9 2.8 2.9 2.7 2.9 3.2 2.6 2.0 1.9 1.9 1.9 1.8 2.0 2.5 2.9 2.5 2.5 2.5 2.1 1.4 1.0 ~, 0.1 0.1 0.2 0.2 0.3 0.3 0.4 0.5 0.5 0.6 0.6 0.6 0.6 0.5 0.5 0.5 0.5 0.5 0.5 0.5 0.5 0.6 0.6 0.6 0.6 0.6 0.5 0.5 0.5 0.5 0.8 0 0.8 0.8 0 0.8 0 0



PANDA RESTAURANT GROUP INC 1683 Walnut Grove Ave. Rosemead, California 91770

> Telephone: 626.799.9898 Facsimile: 626.372.8288

All ideas, designs, arrangement and plans indicated or represented by this drawing are the property of Panda Express Inc. and were created for use on this specific project Vone of these ideas, designs, arrangements or plans may be used by or disclosed to any person, firm, or corporation without the written permission of Panda Express Inc.

	ISIONS:	
	_	
ISSI	UE DATE:	
IDD.	PLANNING	09.3
1ST	T EXTITION 1	
	- I MINING	
	T EMINARYO	
	T EMILITARY	

DRAWN BY: VTL

PANDA PROJECT #: S8-17-D4987 ARCH PROJECT #: 16044.007

> FOR REFERENCE **ONLY**

ARCHITECT:

Shckloverarchitect

OVERLAND PARK, KS 66210 ph: 913.649.8181 • fx: 913.649.1275

PANDA EXPRESS

FOXWOOD AND DEAN 1927 W. FOXWOOD DRIVE RAYMORE, MO 64083

E-106

SITE LIGHTING FIXTURE SCHEDULE 3 NO SCALE E-106 SITE PHOTOMETRIC PLAN

SITE PHOTOMETRIC PLAN